Development Services


	Case No.: BDA 245-014 RECEIVED
Data Relative to Subject Property:	Date:
Location address: 3146 Clydedake	Zoning District: R -7.5
Lot No.: 2 Block No.: 6/3774 Acreage: 0.19	SQ Census Tract:
Street Frontage (in Feet): 1) 52 2 2 3)	5)
To the Honorable Board of Adjustment:	
Owner of Property (per Warranty Deed):	Mende 2
Applicant: Mauca Cardenas	Telephone: 469 9961545
Mailing Address: 1801 P. Hampton Rd.	Desoto 1/2 Zip Code: 75115
E-mail Address: Susancaidenas 200 g mai	1. com
Represented by:	Telephone:
Mailing Address:	Zip Code:
E-mail Address: Affirm that an appeal has been made for a Variance or Sp yarlance for special Set back at 0 Pt. BC	secial Exception of regresting a
Application is made to the Board of Adjustment, in accordance Grant the described appeal for the following reason: requesting a variousce for Specardia form	
Note to Applicant: If the appeal requested in this application is be applied for within 180 days of the date of the final action clonger period. Affidav	of the Board, unless the Board specifically grants a
Before me the undersigned on this day personally appeared	Blanca Cardonas
who on (his/her) oath certifies that the above statements are he/she is the owner/or principal/or authorized representati	(Affiant/Applicant's name printed) e true and correct to his/her best knowledge and that
Respectfully submitted: Agus Caudenas (Affiant/Applicant's signature)	
Subscribed and sworn to before me this	ber , 2024
JENNIFER REYES ID #132388600 My Commission Expires May 13, 2028 Notary Public in and f	for Dallas County, Texas


ArcGIS Web Map



Denotes Esti, TomTom, Garmin, FAO NOAA, USGS, © OpenStreetMap contributors, and the GIS User Community



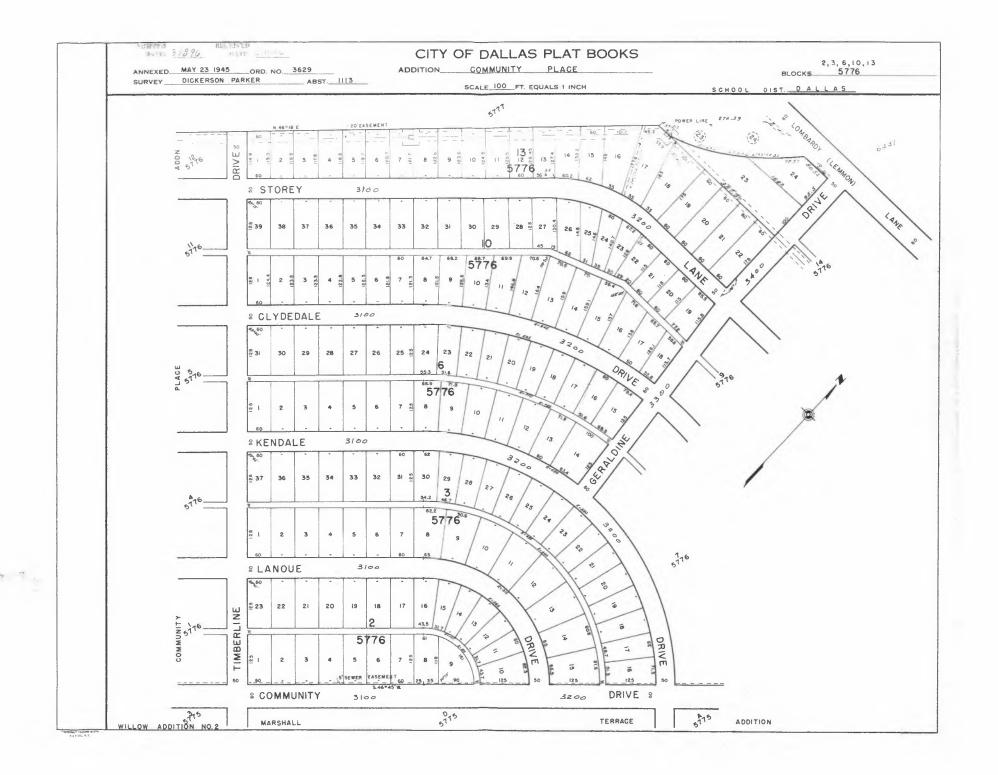

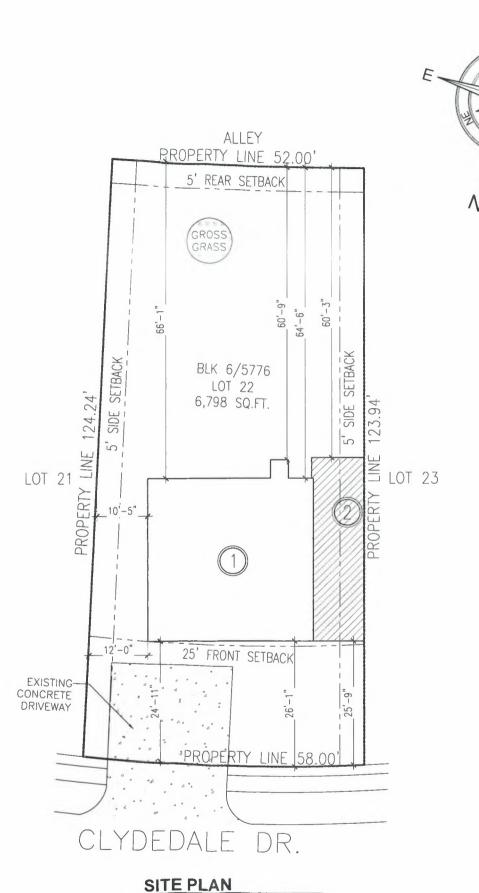

SCALE 1" = 20'



VICINITY MAP

1	EXISTING LIVING AREA	1,176 SQ. FT
2	PROPOSED LIVING AREA (ADDITION)	398 SQ. FT.
	TOTAL COVERAGE	1,574 SQ. FT.
	TOTAL LIVING AREA	1,574 SQ. FT.
	LOT AREA	6,798 SQ.FT.
	% LOT COVERAGE	23.15 %
	LEGAL DESCRIPTION	

Z. DEN 1

4: INT201500018667 DD01222015 CO-DC

5: 5776 006 02200 1005776 006



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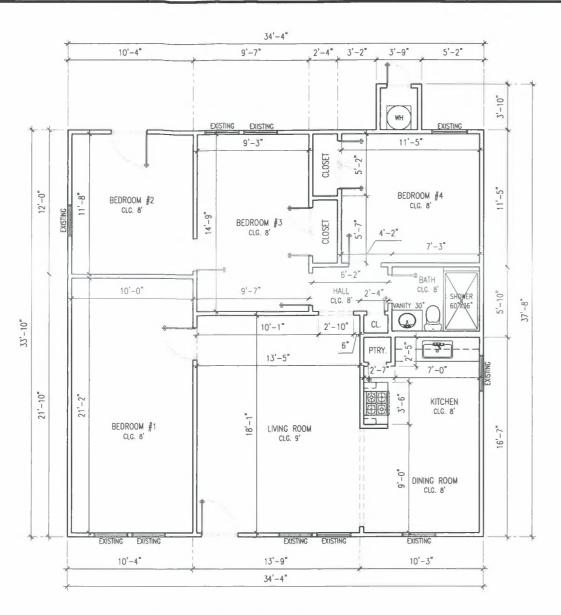
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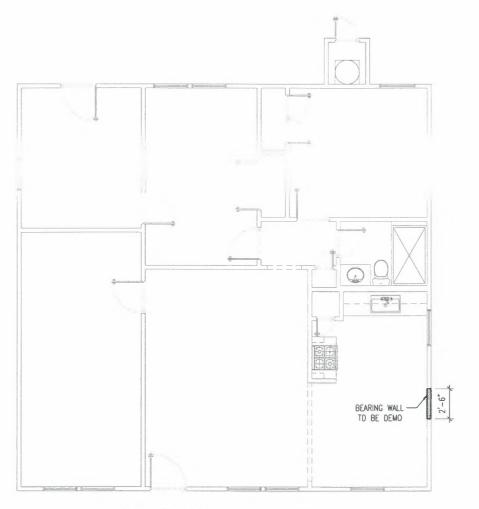
01



EXISTING FLOOR PLAN

SCALE 1/8" = 1'-0"

	SCOPE OF WORK
ITEM	DESCRIPTION
A	PROPOSED LIVING ADDITION (398 SQ.FT.), MUST MATCH EXISTING MATERIALS IN SHAPE, COLOR, ETC., AND MUST COMPLY WITH RESIDENTIAL BUILDING CODE. THE ROOF AFFECTED BY THE ADDITION MUST BE RESTORED AFTER ASSEMBLY OF NEW FRAMING, ALL SHINGLES MUST BE IN GOOD CONDITION AFTER ROOF FINISHING.
В	WALL FINISH, EXTERIOR SIDING, FLODR FINISH AND FOUNDATION TO BE REPAIRED AS NECESSARY. ALL WORK MUST COMPLY WITH CURRENT CITY BUILDING CODE
С	GENERAL ELECTRICAL FIXTURES TO BE REPAIRED AND UPDATED ACCORDING TO NEW LAYDUT, REWIRE WORK AND REPLACEMENT OF ELECTRICAL FIXTURES AT REMODELING SPACES. ALL WORKS MUST BE IN COMPLY WITH CURRENT ELECTRICAL CITY CODE
D	GENERAL PLUMBING ACCESSORIES AND LINES TO BE REPAIRED AND UPDATED ACCORDING TO NEW LAYOUT. ALL WORKS MUST BE IN COMPLY WITH CURRENT PLUMBING CITY CODE



DEMO PLAN

SCALE 1/8" = 1'-0"

ADOPTED CITY CODES:

- 2021 International Building Code
 2021 International Residential Code
 2021 International Energy Conversational Code
 2021 International Fuel Gas Code

- 2021 International Mechanical Code
 2021 International Plumbing Code
 2021 International Existing Building Code
 2021 International Fire Code
- 2020 National Electrical Cade

DEMO PLA	N LEGEND
SYMBOL	DESCRIPTION
	WALL TO BE DEMO



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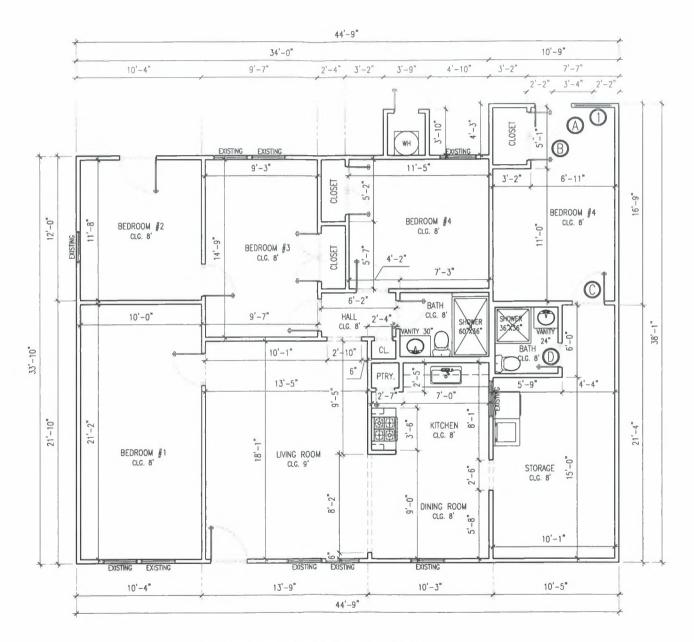
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USE:	RESIDENTIAL ADDITION
PLAN:	EXISTING & DEMO FLOOR PLAN
DRAWN BY:	RC PLANS
DATE:	08/10/2024
SCALE:	1/8" = 1'

ADDRESS:

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PAGE NUMBER:



PROPOSED FLOOR PLAN

IECC 2021 GREEN/ENERGY CODE COMPLIANCE FOR HOME

ALL GREEN/ENERGY SYSTEMS MUST MEET THE REQUIREMENTS FROM THE CHAPTER 4 OF THE INTERNATIONAL ENERGY CONSERVATION CODE, REFERED TO RESIDENTIAL ENERGY EFFICIENCY, IF ANY ITEM IS NOT LISTED BELOW REFER TO THE MENTIONED CHAPTER.

STORMWATER:

1.1.70% OF NON-ROOF AREA HAS VEGETATIVE LANDSCAPE, PERMEABLE PAVING OR SLOPED FOR RUNOFF TO A PERMANENT FILTRATION FEATURE.

WATER EFFICIENCY:
2.1. LAVATORY FAUCETS MUST HAVE AN AVERAGE FLOW RATE OF 2.0 GALLONS PER MINUTE OR LESS.

2.2. SHOWERS HEADS MUST HAVE AN AVERAGE FLOW RATE OF 2.0 GALLONS PER MINUTE OR LESS. 2.3. TOILETS MUST HAVE AN AVERAGE FLOW RATE OF:

2.3.1. LESS THAN OR EQUAL TO 1.3 GALLONS PER FLUSH.
2.3.2. DUAL FLUSH COMPLYING WITH ASME A 112.19.14.
2.3.3. COMPLY WITH US EPA WATER SENSE.

2.4 ENERGY STAR DISHWASHER

2.5.ENERGY STAR CLOTHES WASHER.

HEAT ISLAND MITIGATION:
3.1.ENERGY STAR QUALIFIED ROOF SYSTEM FOR ROOF WITH SLOPE OF 2:12 OR GREATER.
3.2.RADIANT BARRIER IN ATTIC WITH CONVENTIONAL SHINGLES.

3.2 ENCAPSULATED FOAM INSULATION BETWEEN THE ROOF RAFTERS (R-22 OR GREATER)
3.4 WINDOWS AND DOORS MUST BE SEALED WITH FOAM OR CAULK
3.5 SILL PLATE MUST BE SEALED ON THE INSIDE WITH FOAM OR CAULK
3.6 ALL WALL PENETRATIONS TO THE EXTERIOR MUST BE SEALED WITH FOAM OR CAULK
3.7 BLOWER DOOR TESTING IS MANDATORY NOT TO EXCEED 4 AIR CHANGES PER HOUR AT 50

PASCALS

4 DUCTS AND AIR SEALING 4.1 DUCTS MUST BE TESTED AND VERIFIED TO HAVE TOTAL LEAKAGE OF NO MORE THAN 4 FT*/MIN PER 100 SQUARE FOOT (OR 3 CFM IF AIR HANDLER IS NOT INSTALLED), EXCEPT WHERE AIR HANDLER AND ALL DUCTS ARE LOCATED INSIDE CONDITIONED SPACE. AIR HANDLERS AND

FILTER BOXES MUST ALSO BE PROPERLY SEALED

4.2.HVAC AND DUCTWORK LOCATED OUTSIDE OF FIRE RATED ENVELOPE OF GARAGE.
4.3.THE BUILDING ENVELOPE IS REQUIRED TO BE PROPERLY SEALED AND TESTED, AND VERIFIED

AS HAVING AN AIR LEAKEAGE RATE NO HIGHER THAN 3 ACH AT 0.20 INCH W.G. (50 PASCALS).

4.4. SUPPLY AND RETURN DUCTS IN ATTICS SHALL BE SEALD AND INSULATED WITH R-8 WHEN DUCTS IS 3" OR GREATER, R-6 WHEN 3" OR LESS AND EXEMPT WHEN COMPLETELY INSIDE CONDITIONED SPACE

5. INSULATION: 5.1. ALL WINDOWS FENESTRATION U-FACTOR FOR CITY MUST BE 0,35, SKYLIGHT U-FACTOR 0.55 AND

GLAZED FENESTRATION SHGC 0.25.
5.2.CEILINGS MUST BE INSULATED WITH R-38, IF NO ATTIC SPACE R-30, THIS REDUCTION IS LIMITED TO 500 SQUARE FEET (46 M²) OR 20% OF THE TOTAL INSULATED CEILING AREA, WHICHEVER IS

LESS.

5.3. ATTIC ACCESS LADDERS AND OR HATCHES, MUST BE INSULATED THE SAME AS THE ATTIC AND

HAVE A WEATHER SEAL

5.4. ALL EXTERIOR WALLS MUST BE INSULATED WITH R-20 CANITY OR R-13 CANITY WITH R-5 CONTINIOUS INSULATION OR HIGHER

5.5. CRAWL SPACE WALLS MUST BE INSULATED WITH T-5 CONTINIOUS OR R-13 CAVITY INSULATION, WITH VAPOR BARRIER OVER EXPOSED EARTH...
5.6. PIER AND BEAM OR ANY OTHER RAISED FLOOR SYSTEM MUST BE INSULATED WITH R-19

INSULATION OR HIGHER.

6. <u>HVAC SYSTEMS</u>
6.1.TEMPERATURE CONTROLS MUST BE INSTALLED, INCLUDING A PROGRAMMABLE THERMOSTAT
CONTROLLING THE PRIMARY HEATING AOD COOLING SYSTEM.
MECHANICAL SYSTEM PIPING MUST BE INSULATED TO A MINIMUM OF R-3. HOT WATER PIPING %*

IN DIAMETER OR LARGER AND ALL HOT WATER PIPING IN CERTAIN APPLICATIONS MUST BE

6.2. PIPES CARRYING FLUID OVER 104° OR BELOW 55° MUST BE INSULATED WITH R-13.

6.3.LIGHTNING:
6.4.A MINIMUM OF 75% OF LAMPS IN PERMANENTLY INSTALLED FIXTURES MUST BE HIGH-EFFICACY AS DEFINED IN THE IECC.

	WINDOW SCH	HEDULE	
ITEM	SIZE	QUANTITY	TYPE
1	3'-0" X 4'-0"	1	SH

SH = SINGLE HUNG

	DOORS SCH	EDULE	
ITEM	SIZE	QUANTITY	TYPE
A	3'-0" X 6'-8"	1	SHS/GLSS
В	5'-0" X 6'-8"	1	FR
С	2'-8" X 6'-8"	1	SHH
D	2'-0" X 6'-8"	1	SHH

SHH = SINGLE HINGED HOLLOW CORE SHS = SINGLE HINGED SOLID CORE

FR = FRENCH DOOR

GLSS = GLASS PANEL

ADOPTED CITY CODES:

2021 International Building Code

2021 International Residential Code

 2021 International Energy Conversational Code 2021 International Fuel Gas Code

2021 International Mechanical Code

2021 International Plumbing Code

2021 International Existing Building Code

2021 International Fire Code

2020 Notional Electrical Code



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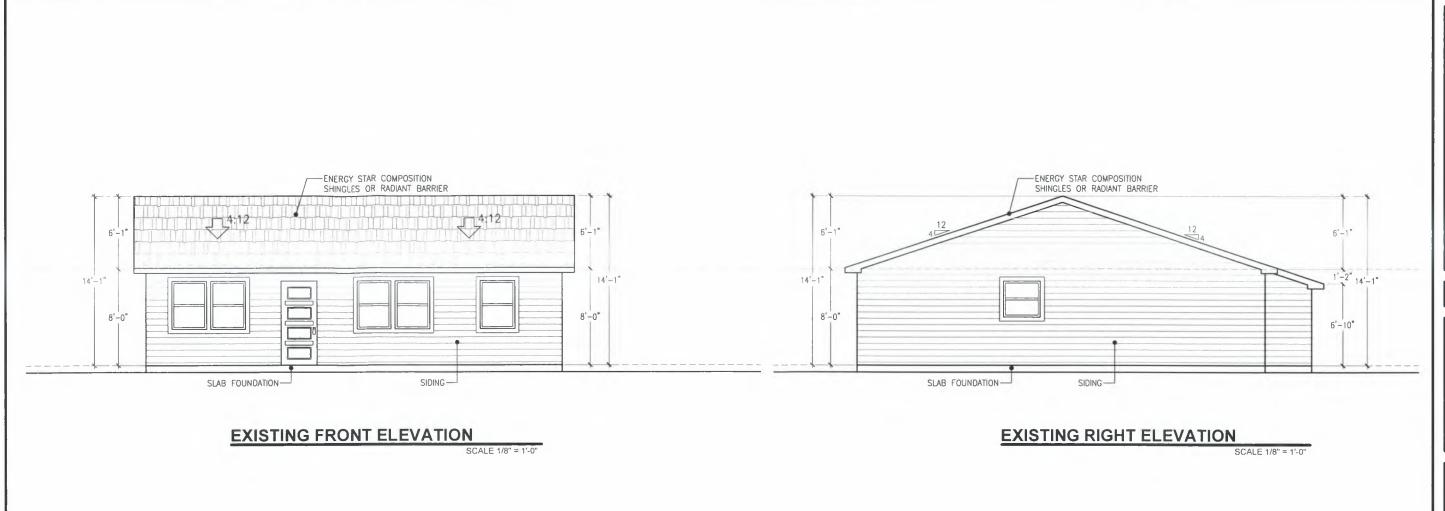
USE: RES	PLAN: FLC	DRAWN BY: RC !	DATE: 08/1	SCALE: 1/8" = 1'
RESIDENTIAL ADDITION	FLOOR PLAN	RC PLANS	08/10/2024	= 1'


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USE:	RESIDENTIAL ADDITION
PLAN:	ELEVATIONS PLAN
DRAWN BY:	RC PLANS
DATE:	08/10/2024
SCALE:	1/8" = 1'


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ENERGY STAR COMPOSITION SHINGLES OR RADIANT BARRIER 6'-1" 6'-10" 8'-0" SIDING SLAB FOUNDATION


EXISTING REAR ELEVATION

SCALE 1/8" = 1'-0"

EXISTING LEFT ELEVATION

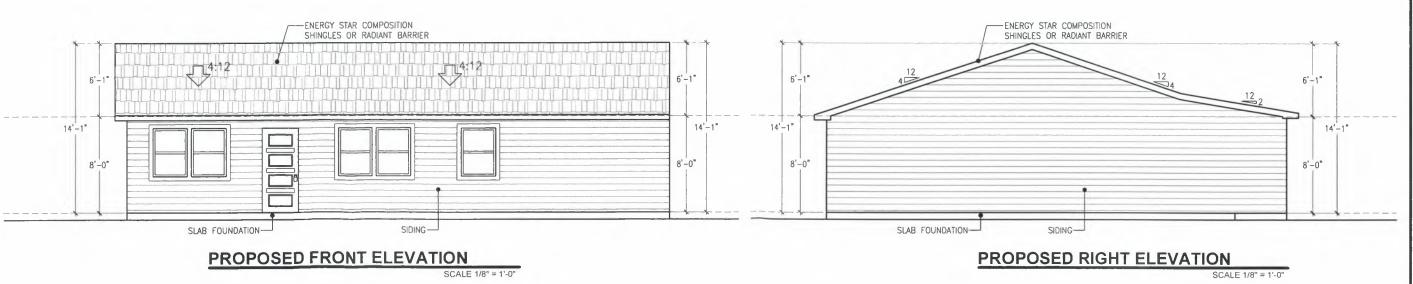SCALE 1/8" = 1'-0"

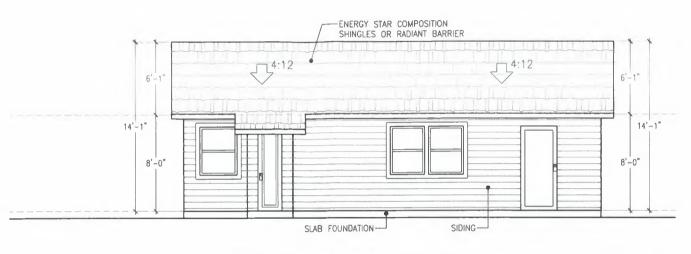

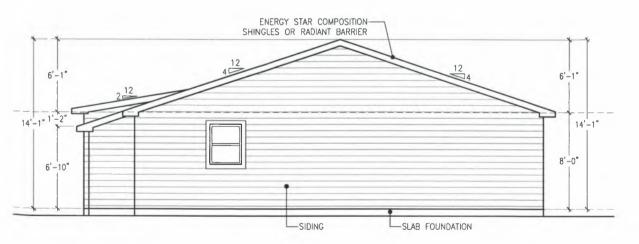

PROPOSED REAR ELEVATION

SCALE 1/8" = 1'-0"

PROPOSED LEFT ELEVATION

CALE 1/8" = 1'-0"

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