	Case No.: BDA 245-01SRECEIV			
Data Relative to Subject Property:	D-D to			
Location address: 6356 Deuhai	Zoning District:			
Lot No.: 2 Block No.: ビーレン ろ Acreage: _ E	· /			
Street Frontage (in Feet): 1) 2) 3)	4)5)			
To the Honorable Board of Adjustment:				
Owner of Property (per Warranty Deed):	Gutierrez			
Applicant: Blancy Cardenas	Telephone: 4699961545-			
Mailing Address: 1001 N. Hampton	Zip Code: 75115			
E-mail Address: SUSANCA rdenas 202 gu	rail.com			
Represented by:	Telephone:			
Mailing Address:	Zip Code:			
E-mail Address:				
Affirm that an appeal has been made for a Variance 2, o for AN AAU Additional JU Not For vent BC	pr Special Exception_ of <u>requesting</u> to Varian (Velling unit proposal			
Grant the described anneal for the following reason:	dance with the provisions of the Dallas Development Code, to Additional Swelling Unit			
Note to Applicant: If the appeal requested in this applicati be applied for within 180 days of the date of the final action onger period.	ion is granted by the Board of Adjustment, a permit must ion of the Board, unless the Board specifically grants a			

evelopment Services

Affidavit

Before me the undersigned on this day personally appeared

Bauca Cardenas

(Affiant/Applicant's name printed) who on (his/her) oath certifies that the above statements are true and correct to his/her best knowledge and that he/she is the owner/or principal/or authorized representative of the subject property

devar Planely Respectfully submitted:

(Affiant/Applicant's signature)

Subscribed and sworn to before me this ______day of



Notary Public in and for Dallas County, Texas

ArcGIS Web Map




Sources Esn, TomTom, Garmin, FAO, NOAA, USGS, © UpenStreetMap contributors, and the GIS User Community

0 12 km

0.06




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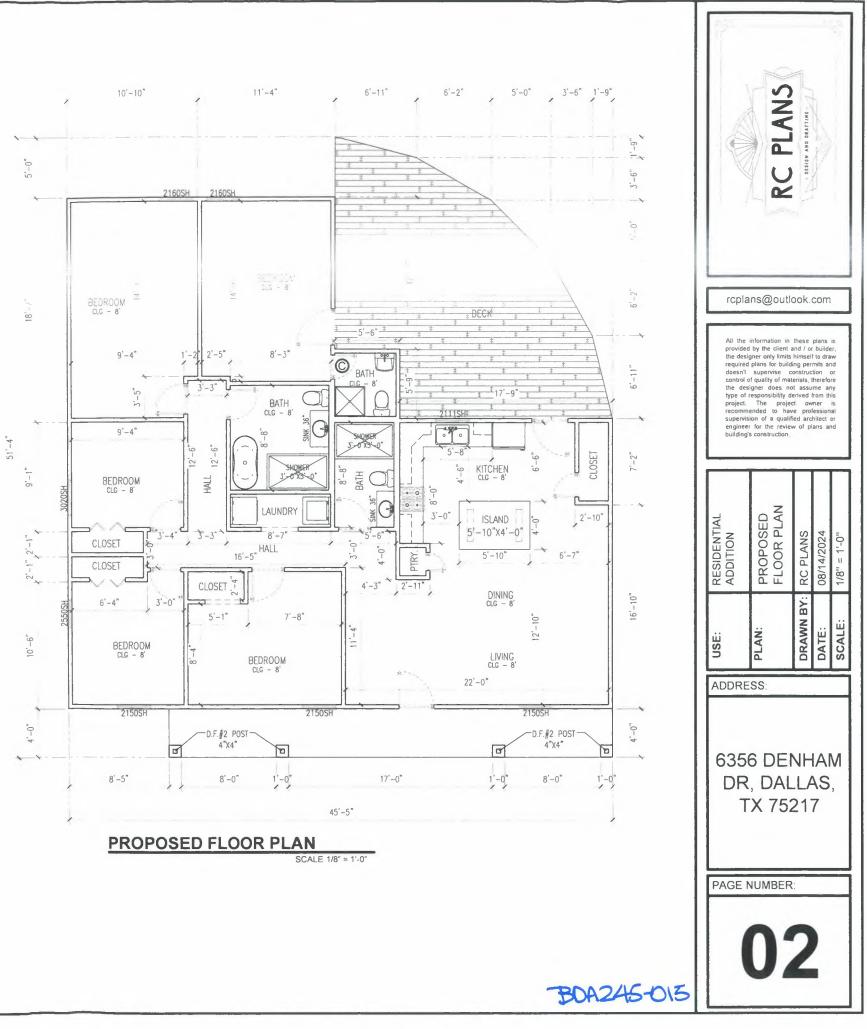


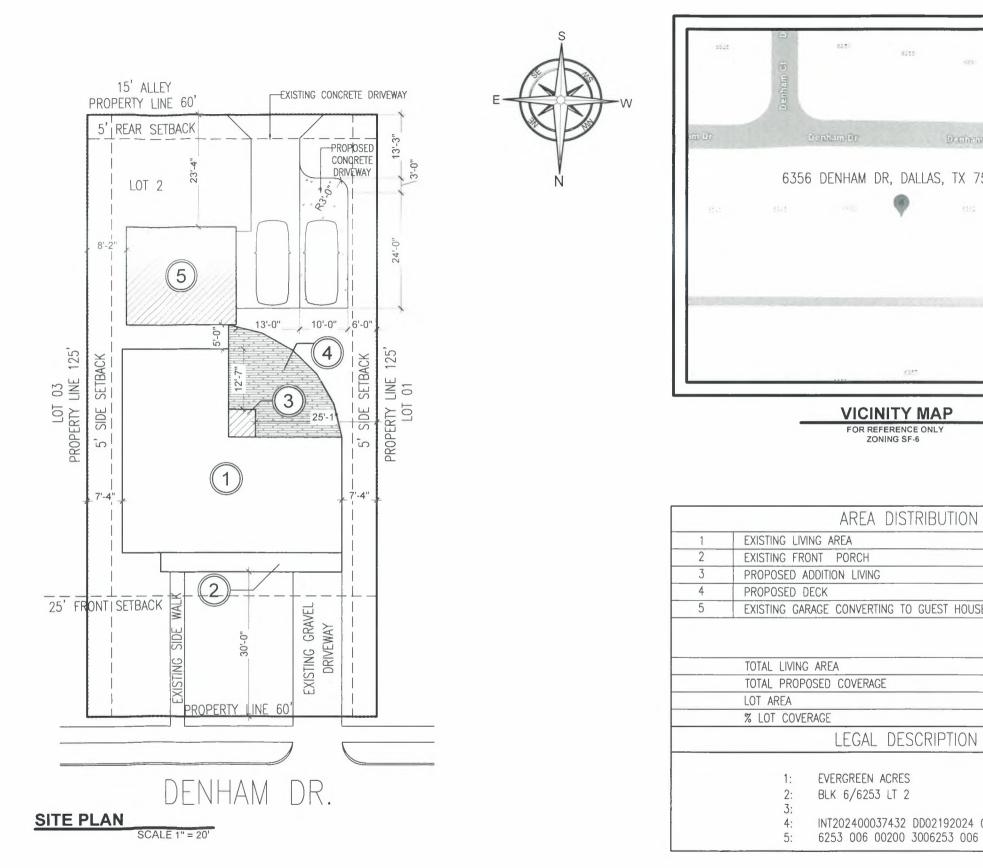
				17-				
64	cit.				RC PLANS	DHILLER AND BERTH		
5217	Denia				RC	N 91838	ľ	
				rcpla	ns@outle	ook.	com	
				provided the desin required doesn't control of the des type of project recomm supervis enginee	information in by the client a gner only limits supervise c d quality of mat igner does no responsibility d The projec ended to hav ion of a qualifi for the review s construction.	ind / or himsel ing per onstruc- enals, I assu- erived ct ow e pro- red arc	r builde I to dra mits an therefor ime an from the mer fession thitect	er. Iw or re ny is is is or
	SQ. FT. SQ. FT.			RESIDENTIAL ADDITION	SITE PLAN	RC PLANS	08/14/2024	1"=20'
364	iQ. FT. SQ. FT. SQ. FT.			USE:	PLAN:	DRAWN BY:	DATE:	SCALE:
2,506 7,500	SQ. FT. SQ. FT. SQ. FT.			DR T	SS: 6 DEI , DAL X 752	.L/ 21	٩S	
	BDA	245-015	5		0	1		

10'-10" 45'-5" , 3'-2" , 20'-1" 11'-4" 10'-10" 1 1 2160SH 2160SH 2160SH

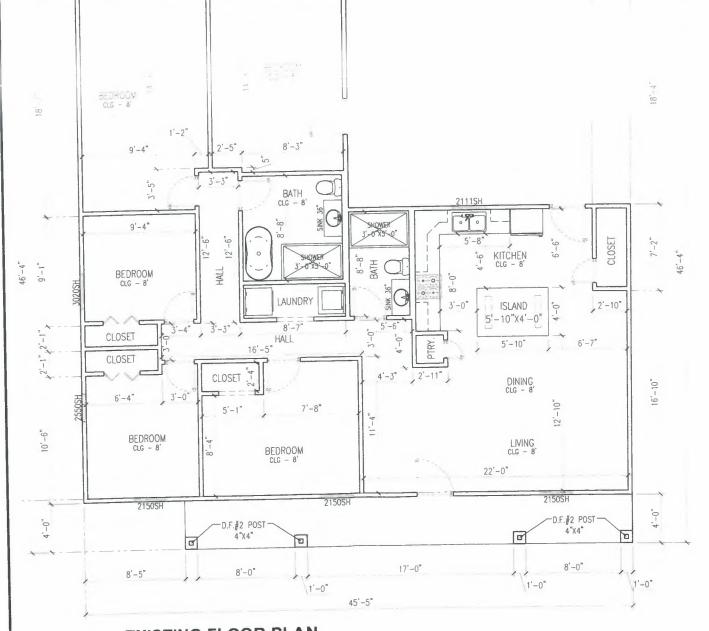

EXISTING FLOOR PLAN SCALE 1/8" = 1'-0"



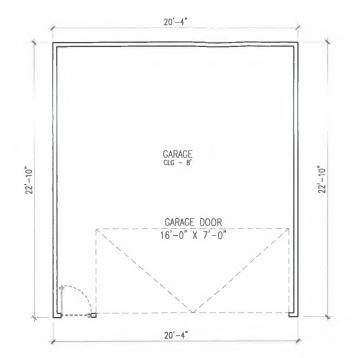

B "2" BEDROOM BEDROOM ö CLG - 8 CLG - 8' Î.O. 7'-2" ® 10" \odot \odot - 9 10" CLOSET BATH O 22'-23 5'-10" 9'-2' 10'-4" LIVING alg - 8' KITCHENETTE CLG - 8 3'-0" 2'-0" 20'-4"

20'-4"

2'-4"

8'-8"

Ó

5'-3"

3'-5"

9'-4"

Ô

4'-4"

5'-0"

EXISTING GARAGE FLOOR PLAN SCALE 1/8" = 1'-0"

WINDOWS	SCHEDULE	

ITEM	SIZE	QUANTITY	TYPE
1	3'-0" X 5'-0"	2	SH

SH = SINGLE HUNG

DOORS SCHEDULE				
ITEM	SIZE	QUANTITY	ТҮРЕ	
A	2'-6" X 6'-8"	2	SHS	
В	2'-4" X 6'-8"	2	SHH	
С	2'-0" X 6'-8"	2	SHH	

SHS = SINGLE HINGED SOLID CORE SHH = SINGLE HINGED HOLLOW CORE

PROPOSED GUEST ROOM **FLOOR PLAN** SCALE 1/8" = 1'-0"

-	
I	ECC 2021 GREEN/EN
А	LL GREEN/ENERGY SYSTEMS MUST
	ITERNATIONAL ENERGY CONSERVAT
	NY ITEM IS NOT LISTED BELOW REFE
1	STORMWATER
	1 1 70% OF NON-ROOF AREA HAS VI
	RUNOFF TO A FERMANENT FILTR
2	WATER EFFICIENCY
	2.1 LAVATORY FAUCETS MUST HAVE
	LESS
	2 2 SHOWERS HEADS MUST HAVE A
	2 3 TOILETS MUST HAVE AN AVERAG
	2 3 1 LESS THAN OR EQUAL TO
	2.3.2 DUAL FLUSH COMPLYING V
	233 COMPLY WITH US EPA WA
	2.4 ENERGY STAR DISHWASHER
	2.5 ENERGY STAR CLOTHES WASHE
3	
	3.1 ENERGY STAR OUALIFIED ROOF
	3 2 RADIANT BARRIER IN ATTIC WITH
	3 3 ENCAPSULATED FOAM INSULATE
	3 4 WINDOWS AND DOORS MUST BE
	3.5 SILL PLATE MUST BE SEALED ON
	3.6 ALL WALL PENETRATIONS TO TH
	3 7 BLOWER DOOR TESTING IS MAN
	PASCALS
÷	DUCTS AND AIR SEALING
	4 1 DUCTS MUST BE TESTED AND VI
	PER 100 SOUARE FOOT (OR 3 CF)
	-41,0 ER 11,0 A 0100 A-2 10
	ENTER AT LEAST OF A REPAIR
	A. 1990 M. 1997 M. 1997 M. 1997
	and the second of the second
	1999, 1997, 44, 1987, 499, 494 44, 1997, 497, 497, 576, 576, 576, 576
	SECREPTER REACTED
	SPACE
5	NSULATION
	5.1 ALL WINDOWS FENESTRATION L
	FENESTRATION SHGC 0 25 MAX
	5 2 CEILINGS MUST BE INSULATED V
	TO 500 SOUARE FEET (46 N') OR 2
	LESS
	53 ATTIC ACCESS LADDERS AND OI
	HAVE A WEATHER SEAL
	5 4 ALL EXTERIOR WALLS MUST BE
	CONTINUOUS INSULATION OR HID
	5.5 CRAWL SPACE WALLS MUST BE
	WITH VAPOR BARRIER OVER EXP
	5.6 PIER AND BEAM OR ANY OTHER
	INSULATION OR HIGHER
6	HVAC SYSTEMS
1	6.1 TEMPERATURE CONTROLS MUS
	CONTROLLING THE PRIMARY HEA
	MECHANICAL SYSTEM PIPING MU
	IN DIAMETER OR LARGER AND AL
	INSULATED TO R-3
	6.2 PIPES CARRYING FLUID OVER 10
	6 3 LIGHTNING
	6 4 A MINIMUM OF 75% OF LAMPS IN
	AS DEFINED IN THE IECC

	SCO
ITEM	
А	A ARE THE F
В	PRO AND BY RE
С	WALI REPA
D	THI REPLA

CURRENT CITY CODES:

