Record Summary for Board of Adjustments

Record

Record # Status Opened Date

BOA-25-000082 In Review 11/04/2025

Application Name

Detailed Description

REQUESTING A VARIANCE TO A SPECIAL SETBACK ,TO BUILD A STRUCTURE W/ A 20 FT FRONT YARD

Assigned To Department Assigned to Staff

Board of Adjustment Diana Barkume

Record Type

Board of Adjustments

Custom Fields

INTERNAL USE ONLY

Source of Request -

Fee Waiver Granted -

Number of Parking Spaces -

Lot Acreage -

PDOX INFORMATION

PDox Number -

PROPERTY INFORMATION

Existing Zoning PD

Lot Number 11

Lot Size (Acres) 0.138

Block Number 154/3213

Lot Size (Sq. Ft) 6000

How many streets abut the property?

Land Use RESIDENTIAL

Is the property platted?

Status of Project Proposed

Status of Property Vacant Land

Previous Board of Adjustment case filed on this property No

Accommodation for someone with disabilities No

File Date -

Seleccione si necesitara un interprete UNCHECKED

Case Number -

Are you applying for a fee waiver?

Page 1 of 3 BOA-25-000082

Have the standards for variance and or special exception

been discussed?

Yes

Has the Notification Sign Acknowledgement Form been

discussed?

No

Referred by

LANITA JACQUES

Custom Lists

Board of Adjustment Request

1

Type of Request Variance
Request Description Front-yard

Application Type Single Family/Duplex Variance or Special Exception

Affirm that an appeal has been made for SETBACK FOR 20 FT FRONT YARD

Application is made to BOA to grant the described appeal

REQUESTING A FRONT SETBACK OF 20 FT TO BUILD A STRUCTURE

GIS Information

1

Census Tract Number 80.05

Council District 1-Chad West

Street Frontage Information

1

Street Frontage Front
Linear Feet (Sq. Ft) 60

Contact Information

Name	Organization Name	Contact Type	Phone
CHAD MILLS		Applicant	2143106944

Email: CMILLS@375RESTORATIONS.COM

Name	Organization Name	Contact Type	Phone
OAKCLIFF COMMUNITY		Property Owner	2143106944

DEVELOPMENT

Email: SHEINRICH@375RESTORATIONS.COM

Address

117 N VAN BUREN AVE, Dallas, TX 75208

Page 2 of 3 BOA-25-000082

Parcel Information

Parcel No: Land Value Legal Book Page Lot Block Subdivision Description

003213015411A000

0


Owner Information


Primary	Owner Name	Owner Address	Owner Phone
Y	NORTH OAK CLIFF COMMUNITY	PO BOX 1850, COPPELL, TEXAS 750191801	


Status History

Status	Comment	Assigned Name	Status Date
Application About to Expire	Updated via: BATCH_BUILDING_ABOUT_TO_EXPIRE	Accela Administrator	11/19/2025
In Review		Diana Barkume	11/20/2025
Payment Due		Diana Barkume	12/02/2025
In Review	Updated By Script	Accela Administrator	12/04/2025
In Review		Anna Brickey	12/05/2025

Page 3 of 3 BOA-25-000082

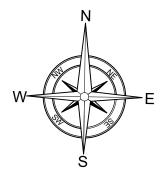


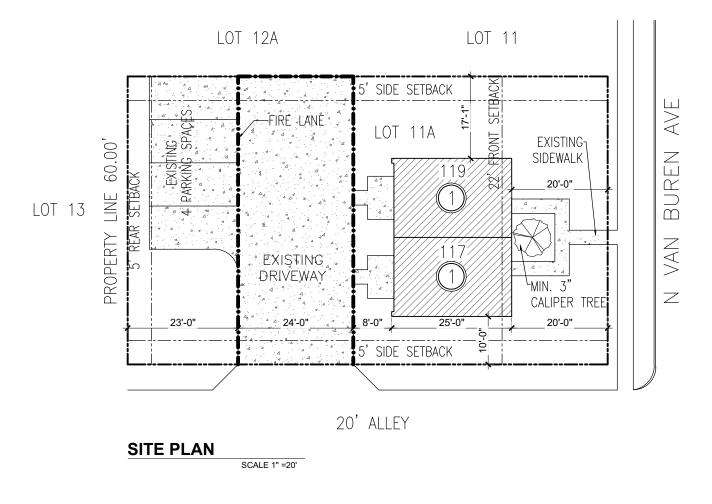

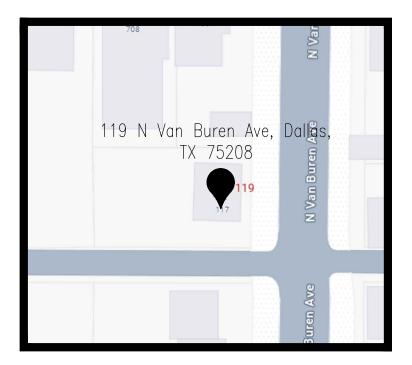

VICINITY MAP FOR REFERENCE ONLY

	T .	REA SCHEDULE BY SUITE	
	1	PROPOSED LIVING AREA 1st STORY	405 SQ. FT
LINUT			
UNIT 1	2	PROPOSED LIVING AREA 2nd STORY	356 SQ. FT
'	TOTAL	LIVING AREA	761 SQ. FT
	TOTAL	PROPOSED COVERAGE	405 SQ. FT
	1	PROPOSED LIVING AREA 1st STORY	405 SQ. FT
UNIT	2	PROPOSED LIVING AREA 2nd STORY	356 SQ. FT
2	TOTAL	LIVING AREA	761 SQ. FT
	TOTAL	PROPOSED COVERAGE	405 SQ. FT
	•		
	TOTAL	PROPOSED COVERAGE	810 SQ. FT
	LOT AF	REA	6,000 SQ. F
	% LOT	COVERAGE	13.5 %
	Ĺ	EGAL DESCRIPTION	

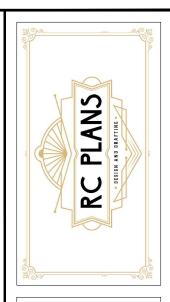

214-859-4267


THESE PLANS AND SPECIFICATIONS ARE INTENDED SOLELY FOR USE ON THE DESIGNATED SITE FOR WHICH THEY WERE CREATED. ANY REPRODUCTION OR DISTRIBUTION IS STRICTLY CONFINED TO THIS PURPOSE. REPRODUCTION, REUSE, OR DISCLOSURE—WHETHER IN FULL OR PARTIAL FORM AND BY ANY MEANS—OUTSIDE OF THIS INTENDED USE IS PROHIBITED. RCPLANS LLC RETAINS OWNERSHIP AND PROPRIETARY RIGHTS TO THE INFORMATION CONTAINED WITHIN THESE DRAWINGS AND SPECIFICATIONS.


USE:	RESIDENTIAL NEW DUPLEX CONSTRUCTION
PLAN:	SITE PLAN
DRAWN BY: RC PLANS	RC PLANS
DATE:	11/18/2024
SCALE:	1"=20'

ADDRESS:

117-119 N VAN BUREN AVE, DALLAS, TX 75208

PAGE NUMBER:

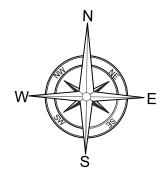

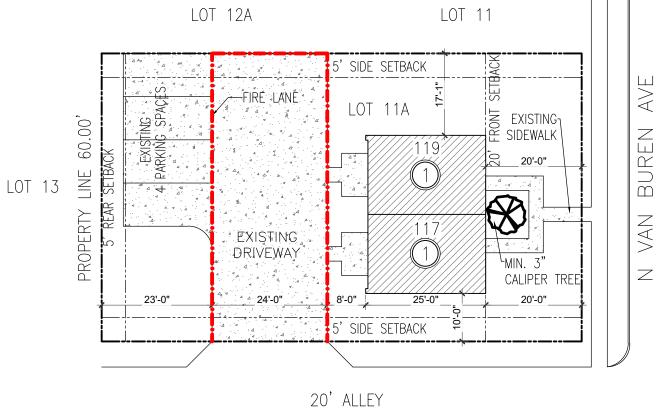

SITE PLAN

SCALE 1" =20'




119 N Van Buren Ave, Dalges,
TX 75208

119

N Van Buren Ave, Dalges,
TX 75208

VICINITY MAP
FOR REFERENCE ONLY

	AREA SCHEDULE BY SUITE	-
	1 PROPOSED LIVING AREA 1st STO	RY 405 SQ. FT.
UNIT		
1	2 PROPOSED LIVING AREA 2nd STOP	RY 356 SQ. FT.
'	TOTAL LIVING AREA	761 SQ. FT.
	TOTAL PROPOSED COVERAGE	405 SQ. FT.
	1 PROPOSED LIVING AREA 1st STO	RY 405 SQ. FT.
UNIT 2	2 PROPOSED LIVING AREA 2nd STOP	RY 356 SQ. FT.
Z	TOTAL LIVING AREA	761 SQ. FT.
	TOTAL PROPOSED COVERAGE	405 SQ. FT.
		·
	TOTAL PROPOSED COVERAGE	810 SQ. FT.
	LOT AREA	6,000 SQ. FT.
	% LOT COVERAGE	13.5 %
•	LEGAL DESCRIPTION	
	JEFFREY SQUARE BLK 154/3213 LT 11A AC	S 0.1377

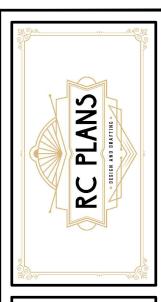

214-859-4267

THESE PLANS AND SPECIFICATIONS ARE INTENDED SOLELY FOR USE ON THE DESIGNATED SITE FOR WHICH THEY WERE CREATED. ANY REPRODUCTION OR DISTRIBUTION IS STRICTLY CONFINED TO THIS PURPOSE. REPRODUCTION, REUSE, OR DISCLOSURE—WHETHER IN FULL OR PARTIAL FORM AND BY ANY MEANS—OUTSIBE OF THIS INTENDED USE IS PROHIBITED. RCPLANS LLC RETAINS OWNERSHIP AND PROPRIETARY RIGHTS TO THE INFORMATION CONTAINED WITHIN THESE DRAWINGS AND SPECIFICATIONS.

USE:	RESIDENTIAL NEW DUPLEX
	CONSTRUCTION
PLAN:	SITE PLAN
DRAWN BY:	RC PLANS
DATE:	11/18/2024
SCALE:	1"=20"


ADDRESS:

117 N VAN BUREN AVE, DALLAS, TX 75208

PAGE NUMBER:

01

12/16/2024

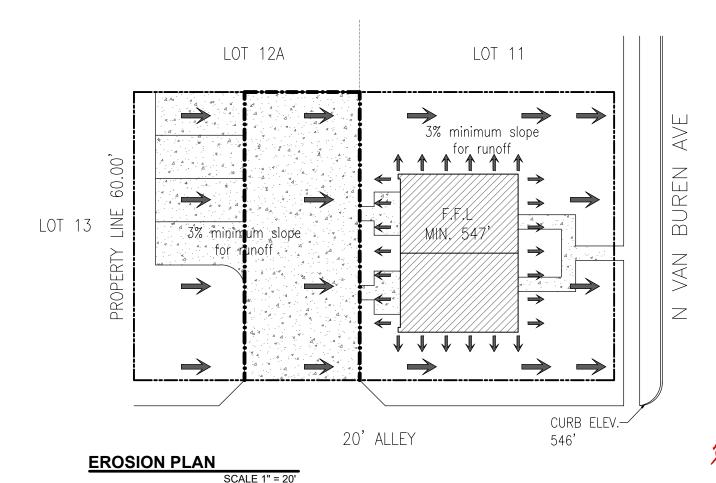



SILT FENCE NOTES:

1. STEEL POSTS WHICH SUPPORT THE SILT FENCE SHALL BE INSTALLED ON A SLIGHT ANGLE TOWARD THE ANTICIPATED RUNOFF SOURCE.

2. THE TOE OF THE SILT FENCE SHALL BE TRENCHED IN WITH A SPADE OR MECHANICAL TRENCHER, SO THAT THE DOWN SLOPE FACE OF THE TRENCH IS FLAT AND PERPENDICULAR TO THE LINE OF FLOW.

- 3. THE TRENCH SHOULD BE A MINIMUM OF SIX INCHES DEEP AND SIX INCHES WIDE TO ALLOW FOR THE SILT FENCE TO BE LAID IN THE GROUND AND BACKFILLED.
- 4. SILT FENCE SHOULD BE SECURELY FASTENED TO EACH SUPPORT POST.
- 5. INSPECTION SHALL BE FREQUENT AND REPAIR OR REPLACEMENT SHALL BE MADE PROMPTLY AS NEEDED.
- 6. SILT FENCE SHALL BE REMOVED WHEN IT HAS SERVED IS USEFULNESS, SO AS NOT TO BLOCK OR IMPEDE STORM FLOW OR DRAINAGE.
- 7. SEDIMENT TRAPPED BY THIS PRACTICE SHALL BE DISPOSED OF IN AN APPROVED SITE IN A MANNER THAT WILL NOT CONTRIBUTE TO ADDITIONAL SILTATION.
- 8. ACCUMULATED SILT SHALL BE REMOVED WHEN IT REACHES A DEPTH OF SIX INCHES AND DISPOSED OF IN AN APPROVED SPOIL SITE OR AS IN No. 7 ABOVE.
- 9. FILTER FABRIC IS TO BE MIRAFI 100X OR APPROVED EQUAL.
- 10. CONTRACTOR TO REMOVE SILT FENCE UPON COMPLETION OF PROJECT. DAMAGED AREAS TO BE REPAIRED INCLUDING RE-GRADING AND RE-GRASSING AS NECESSARY.
- 11. ALL EROSION CONTROL DEVICES AND REQUIREMENTS TO BE IN ACCORDANCE WITH NCTCOG BMP EROSION CONTROL MANUAL AND PLANS AND SPECIFICATIONS.
- 12. UNLESS APPROVED BY OWNER, EROSION CONTROL FENCING SHALL BE USED IN AREAS WITH NO TREES ONLY.

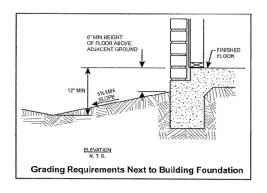

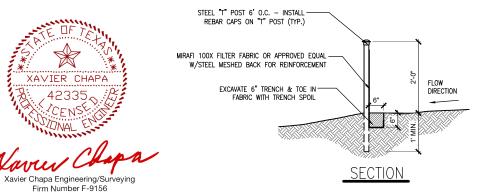


STEEL "T" POST 6' O.C. — INSTALL
REBAR CAPS ON "T" POST (TYP.)

STEEL "T" POST @ 6'-0" O.C.

MIRAFI 100X FILTER FABRIC OR APPROVED
EQUAL W/STEEL MESHED BACK FOR REINFORCEMENT
EXCAVATE 6" TRENCH & TOE IN
FABRIC WITH TRENCH SPOIL

ELEVATION

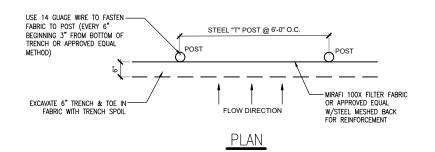

SILT FENCE

12/16/2024

N.T.S.



214-859-4267


THESE PLANS AND SPECIFICATIONS ARE INTENDED SOLELY FOR USE ON THE DESIGNATED SITE FOR WHICH THEY WERE CREATED. ANY REPRODUCTION OR DISTRIBUTION IS STRICTLY CONFINED TO THIS PURPOSE. REPRODUCTION, REUSE, OR DISCLOSURE—WHETHER IN FULL OR PARTIAL FORM AND BY ANY MEANS—OUTSIDE OF THIS INTENDED USE IS PROHIBITED. RCPLANS LLC RETAINS OWNERSHIP AND PROPRIETARY RIGHTS TO THE INFORMATION CONTAINED WITHIN THESE DRAWINGS AND SPECIFICATIONS.

USE:	RESIDENTIAL NEW
	DUPLEX
	CONSTRUCTION
PLAN:	SITE PLAN
DRAWN BY:	RC PLANS
DATE:	11/18/2024
SCALE:	1"=20'

ADDRESS:

117 N VAN BUREN AVE, DALLAS, TX 75208

PAGE NUMBER:

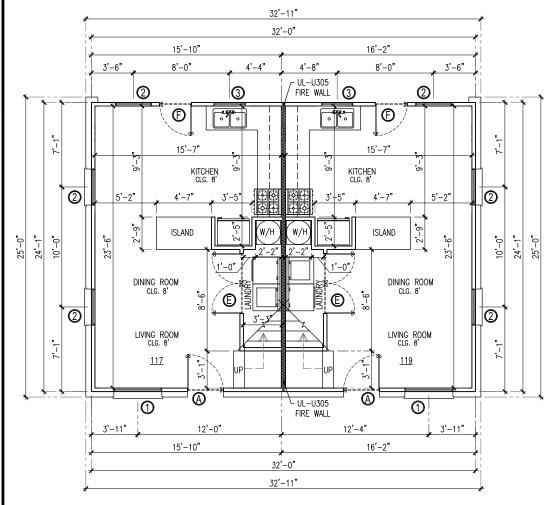

WIN	IDOWS SC	HEDULE	
ITEM	SIZE	QUANTITY	TYPE
1	4'-0" X 5'-0"	4	SH
2	3'-0" X 5'-0"	12	SH
3	3'-0" X 3'-0"	2	SH

SH = SINGLE HUNG

D	OORS SCH	HEDULE	
ITEM	SIZE	QUANTITY	TYPE
A	3'-0" X 7'-0"	2	SHS
В	2'-8" X 6'-8"	2	SHH
С	2'-6" X 6'-8"	4	SHH
D	2'-0"X 6'-8"	4	SHH
E	5'-0" X 6'-8"	2	FR
F	2'-8" X 6'-8"	2	SHS

SHS = SINGLE HINGED SOLID CORE SHH = SINGLE HINGED HOLLOW CORE


FR = FRENCH

NOTE: Quantities inches both units

FLOOR PLAN 1st STORY

SCALE 1/8" = 1'-0"

UL U305

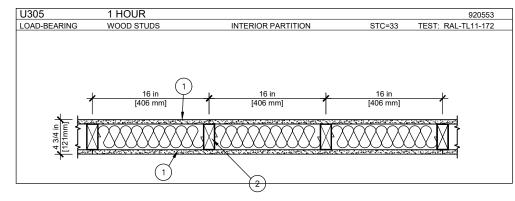

- ONE LAYERS 5/8" SHEETROCK BRAND FIRECODE CORE GYPSUM PANELS OR 5/8" SHEETROCK BRAND WATER RESISTANT FIRECODE CORE GYPSUM PANELS FACH SIDE
- 2. 2" x 4" WOOD STUD AT 16" ON CENTER.

- A. BASE LAYER ATTACHED WITH 1 7/8" NAILS
- AT 6" ON CENTER.
 FACE LAYER ATTACHED WITH 2 3/8" NAILS
- AT 8" ON CENTER.
- JOINTS FINISHED.

FIRE WALL DETAIL NTS.

COMPLIANCE FOR HOME

ALL GREEN/ENERGY SYSTEMS MUST MEET THE REQUIREMENTS FROM THE CHAPTER 4 OF THE INTERNATIONAL ENERGY CONSERVATION CODE, REFERED TO RESIDENTIAL ENERGY EFFICIENCY. IF ANY ITEM S NOT LISTED BELOW REFER TO THE MENTIONED CHAPTER.

IECC 2021 GREEN/ENERGY CODE

1.1.70% OF NON-ROOF AREA HAS VEGETATIVE LANDSCAPE, PERMEABLE PAVING OR SLOPED FOR RUNOFF TO A PERMANENT FILTRATION FEATURE.

2. <u>WATER EFFICIENCY:</u>
2.1.LAVATORY FAUCETS MUST HAVE AN AVERAGE FLOW RATE OF 2.0 GALLONS PER MINUTE OR LESS.

2.2. SHOWERS HEADS MUST HAVE AN AVERAGE FLOW RATE OF 2.0 GALLONS PER MINUTE OR LESS. 2.3. TOILETS MUST HAVE AN AVERAGE FLOW RATE OF:

2.3.1. LESS THAN OR EQUAL TO 1.3 GALLONS PER FLUSH. 2.3.2. DUAL FLUSH COMPLYING WITH ASME A 112.19.14.

2.3.3. COMPLY WITH US EPA WATER SENSE. 2.4.ENERGY STAR DISHWASHER.

2.4: ENERGY STAR CLOTHES WASHER.

3. HEAT ISLAND MITIGATION:
3.1: ENERGY STAR QUALIFIED ROOF SYSTEM FOR ROOF WITH SLOPE OF 2:12 OR GREATER.

3.2: RADIANT BARRIER IN ATTIC WITH CONVENTIONAL SHINGLES.

3.3. ENCAPSULATED FOAM INSULATION BETWEEN THE ROOF RAFTERS (R-22 OR GREATER).

3.4. WINDOWS AND DOORS MUST BE SEALED WITH FOAM OR CAULK.
3.5. SILL PLATE MUST BE SEALED ON THE INSIDE WITH FOAM OR CAULK.
3.6. ALL WALL PENETRATIONS TO THE EXTERIOR MUST BE SEALED WITH FOAM OR CAULK. 3.7. BLOWER DOOR TESTING IS MANDATORY. NOT TO EXCEED 4 AIR CHANGES PER HOUR AT 50

PASCALS.

4. DUCTS AND AIR SEALING

4.1.DUCTS MUST BE TESTED AND VERIFIED TO HAVE TOTAL LEAKAGE OF NO MORE THAN 4 FT?/MIN PER
100 SQUARE FOOT (OR 3 CFM IF AIR HANDLER IS NOT INSTALLED), EXCEPT WHERE AIR HANDLER AND ALL DUCTS ARE LOCATED INSIDE CONDITIONED SPACE. AIR HANDLERS AND FILTER BOXES MUST ALSO BE PROPERLY SEALED.

4.2.HVAC AND DUCTWORK LOCATED OUTSIDE OF FIRE RATED ENVELOPE OF GARAGE.

4.3.THE BUILDING ENVELOPE IS REQUIRED TO BE PROPERLY SEALED AND TESTED, AND VERIFIED AS HAVING AN AIR LEAKEAGE RATE NO HIGHER THAN 3 ACH AT 0.20 INCH W.G. (50 PASCALS).

4.4. SUPPLY AND RETURN DUCTS IN ATTICS SHALL BE SEALD AND INSULATED WITH RE-8 WHEN DUCTS IS 3° OR GREATER, R-6 WHEN 3° OR LESS AND EXEMPT WHEN COMPLETELY INSIDE CONDITIONED

5. INSULATION:
5.1. ALL WINDOWS FENESTRATION U-FACTOR FOR CITY MUST BE 0.35, SKYLIGHT U-FACTOR 0.55 AND GLAZED FENESTRATION SHGC 0.25.

5.2. CEILINGS MUST BE INSULATED WITH R-38, IF NO ATTIC SPACE R-30, THIS REDUCTION IS LIMITED

TO 500 SQUARE FEET (46 M2) OR 20% OF THE TOTAL INSULATED CEILING AREA, WHICHEVER IS

5.3. ATTIC ACCESS LADDERS AND OR HATCHES, MUST BE INSULATED THE SAME AS THE ATTIC AND HAVE A WEATHER SEAL

5.4. ALL EXTERIOR WALLS MUST BE INSULATED WITH R-20 CANITY OR R-13 CANITY WITH R-5

CONTINIOUS INSULATION OR HIGHER.

5.5. CRAWL SPACE WALLS MUST BE INSULATED WITH T-5 CONTINIOUS OR R-13 CAVITY INSULATION,

WITH VAPOR BARRIER OVER EXPOSED EARTH.
5.6.PIER AND BEAM OR ANY OTHER RAISED FLOOR SYSTEM MUST BE INSULATED WITH R-19 INSULATION

6. HVAC SYSTEMS
6.1. TEMPERATURE CONTROLS MUST BE INSTALLED, INCLUDING A PROGRAMMABLE THERMOSTAT CONTROLLING THE PRIMARY HEATING AOD COOLING SYSTEM.

MECHANICAL SYSTEM PIPING MUST BE INSULATED TO A MINIMUM OF R-3. HOT WATER PIPING ¾ IN DIAMETER OR LARGER AND ALL HOT WATER PIPING IN CERTAIN APPLICATIONS MUST BE INSULATED TO

6.2. PIPES CARRYING FLUID OVER 104' OR BELOW 55' MUST BE INSULATED WITH R-13.

6.4. A MINIMUM OF 75% OF LAMPS IN PERMANENTLY INSTALLED FIXTURES MUST BE HIGH-EFFICACY AS

ADOPTED CITY CODES:

- 2021 International Building Code
 2021 International Residential Code
- 2021 International Energy Conversational Code
- 2021 International Fuel Gas Code
- 2021 International Mechanical Code 2021 International Plumbing Code
- 2021 International Existing Building Code
- 2021 International Fire Code 2020 National Electrical Code



Xavier Chapa Engineering/Surveying

12/16/2024




214-859-4267

THESE PLANS AND SPECIFICATIONS ARE INTENDED SOLELY FOR USE ON THE DESIGNATED SITE FOR WHICH THEY VERE CREATED. ANY REPRODUCTION OF WERE CREATED. ANY REPRODUCTION OR DISTRIBUTION IS STRICTLY CONFINED TO THIS PURPOSE. REPRODUCTION, REUSE, OR DISCLOSURE—WHETHER IN FULL OR PARTIAL FORM AND BY ANY MEANS—OUTSIDE OF THIS INTENDED USE. IS PROHIBITED ROPLANS LLC RETAINS S PROHIBITED. ROPLANS LLC RETAINS OWNERSHIP AND PROPRIETARY RIGHTS TO THE INFORMATION CONTAINED WITHIN THESE DRAWINGS AND SPECIFICATIONS.

USE:	RESIDENTIAL NEW DUPLEX CONSTRUCTION
PLAN:	FLOOR PLAN
DRAWN BY:	RC PLANS
DATE:	11/18/2024
SCALE	1/8" = 1'-0"

ADDRESS:

117 N VAN **BUREN** AVE, DALLAS, TX 75208

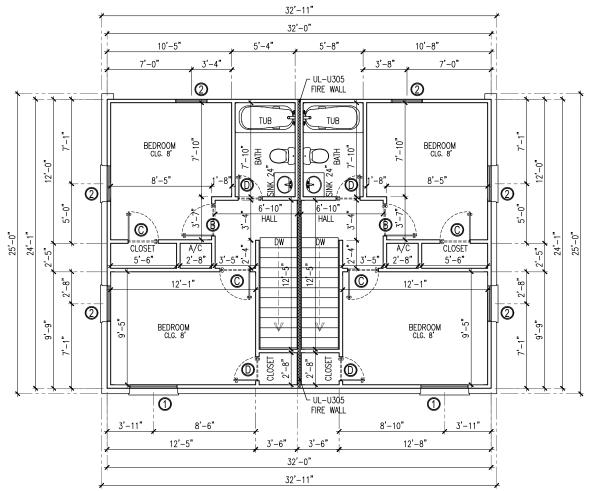

WIN	NDOWS SC	HEDULE	
ITEM	SIZE	QUANTITY	TYPE
1	4'-0" X 5'-0"	4	SH
2	3'-0" X 5'-0"	12	SH
3	3'-0" X 3'-0"	2	SH

SH = SINGLE HUNG

D(OORS SCH	IEDULE		
ITEM	SIZE	QUANTITY	TYPE	
А	3'-0" X 7'-0"	2	SHS	
В	2'-8" X 6'-8"	2	SHH	
С	2'-6" X 6'-8"	4	SHH	
D	2'-0"X 6'-8"	4	SHH	
E	5'-0" X 6'-8"	2	FR	
F	2'-8" X 6'-8"	2	SHS	

SHS = SINGLE HINGED SOLID CORE SHH = SINGLE HINGED HOLLOW CORE FR = FRENCH


FLOOR PLAN 2nd STORY

SCALE 1/8" = 1'-0"

NOTE: Quantities inches both units

UL U305

DETAIL

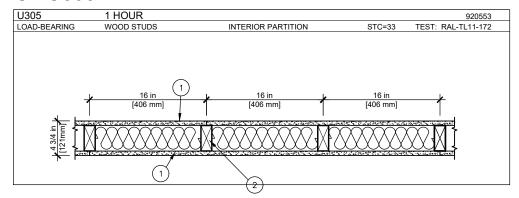

- 1. ONE LAYERS 5/8" SHEETROCK BRAND FIRECODE CORE GYPSUM PANELS OR 5/8" SHEETROCK BRAND WATER RESISTANT FIRECODE CORE
- 2. 2" x 4" WOOD STUD AT 16" ON CENTER

NOTES:

- BASE LAYER ATTACHED WITH 1 7/8" NAILS AT 6" ON CENTER.
- B. FACE LAYER ATTACHED WITH 2 3/8" NAILS
- AT 8" ON CENTER. JOINTS FINISHED.

FIRE WALL

IECC 2021 GREEN/ENERGY CODE COMPLIANCE FOR HOME

ALL GREEN/ENERGY SYSTEMS MUST MEET THE REQUIREMENTS FROM THE CHAPTER 4 OF THE INTERNATIONAL ENERGY CONSERVATION CODE, REFERED TO RESIDENTIAL ENERGY EFFICIENCY. IF ANY ITEM IS NOT LISTED BELOW REFER TO THE MENTIONED CHAPTER.

1.1. 70% OF NON-ROOF AREA HAS VEGETATIVE LANDSCAPE, PERMEABLE PAVING OR SLOPED FOR RUNOFF TO A PERMANENT FILTRATION FEATURE.

2. WATER EFFICIENCY:

2.1. LAVATORY FAUCETS MUST HAVE AN AVERAGE FLOW RATE OF 2.0 GALLONS PER MINUTE OR LESS. 2.2. SHOWERS HEADS MUST HAVE AN AVERAGE FLOW RATE OF 2.0 GALLONS PER MINUTE OR LESS. 2.3. TOILETS MUST HAVE AN AVERAGE FLOW RATE OF: 2.3.1. LESS THAN OR EQUAL TO 1.3 GALLONS PER FLUSH.

2.3.2. DUAL FLUSH COMPLYING WITH ASME A 112.19.14. 2.3.3. COMPLY WITH US EPA WATER SENSE.

2.4.ENERGY STAR DISHWASHER. 2.5.ENERGY STAR CLOTHES WASHER.

- 3. HEAT ISLAND MITIGATION:

 3.1 ENERGY STAR QUALIFIED ROOF SYSTEM FOR ROOF WITH SLOPE OF 2:12 OR GREATER.

 3.2 RADIANT BARRIER IN ATTIC WITH CONVENTIONAL SHINGLES.

 3.3 ENCAPSULATED FOAM INSULATION BETWEEN THE ROOF RAFTERS (R-22 OR GREATER).
- 3.4. WINDOWS AND DOORS MUST BE SEALED WITH FOAM OR CAULK.
 3.5. SILL PLATE MUST BE SEALED ON THE INSIDE WITH FOAM OR CAULK.
 3.6. ALL WALL PENETRATIONS TO THE EXTERIOR MUST BE SEALED WITH FOAM OR CAULK.
- 3.7. BLOWER DOOR TESTING IS MANDATORY. NOT TO EXCEED 4 AIR CHANGES PER HOUR AT 50
- 4. DUCTS AND AIR SEALING

4.1. DUCTS MUST BE TESTED AND VERIFIED TO HAVE TOTAL LEAKAGE OF NO MORE THAN 4 FT3/MIN PER 100 SQUARE FOOT (OR 3 CFM IF AIR HANDLER IS NOT INSTALLED), EXCEPT WHERE AIR HANDLER AND ALL DUCTS ARE LOCATED INSIDE CONDITIONED SPACE. AIR HANDLERS AND FILTER BOXES MUST ALSO BE PROPERLY SEALED.

4.2. HVAC AND DUCTWORK LOCATED OUTSIDE OF FIRE RATED ENVELOPE OF GARAGE

- 4.3. THE BUILDING ENVELOPE IS REQUIRED TO BE PROPERLY SCALED AND TESTED, AND VERIFIED AS
 HAVING AN AIR LEAKEAGE RATE NO HIGHER THAN 3 ACH AT 0.20 INCH W.G. (50 PASCALS).

 4.4. SUPPLY AND RETURN DUCTS IN ATTICS SHALL BE SEALD AND INSULATED WITH R-8 WHEN DUCTS IS
- 3" OR GREATER, R-6 WHEN 3" OR LESS AND EXEMPT WHEN COMPLETELY INSIDE CONDITIONED

- 5. <u>INSULATION:</u>
 5.1. ALL WINDOWS FENESTRATION U-FACTOR FOR CITY MUST BE 0.35, SKYLIGHT U-FACTOR 0.55 AND GLAZED FENESTRATION SHGC 0.25. 5.2. CEILINGS MUST BE INSULATED WITH R-38, IF NO ATTIC SPACE R-30, THIS REDUCTION IS LIMITED
- TO 500 SQUARE FEET (46 M2) OR 20% OF THE TOTAL INSULATED CEILING AREA, WHICHEVER IS
- 5.3. ATTIC ACCESS LADDERS AND OR HATCHES, MUST BE INSULATED THE SAME AS THE ATTIC AND HAVE A WEATHER SEAL
- 5.4. ALL EXTERIOR WALLS MUST BE INSULATED WITH R-20 CANITY OR R-13 CANITY WITH R-5 CONTINIOUS INSULATION OR HIGHER.
- 5.5. CRAWL SPACE WALLS MUST BE INSULATED WITH T-5 CONTINIOUS OR R-13 CAVITY INSULATION, WITH VAPOR BARRIER OVER EXPOSED EARTH.
- OR HIGHER.
- 6. <u>HVAC_SYSTEMS</u>
 6.1. TEMPERATURE CONTROLS MUST BE INSTALLED, INCLUDING A PROGRAMMABLE THERMOSTAT
- CONTROLLING THE PRIMARY HEATING AOD COOLING SYSTEM.

 MECHANICAL SYSTEM PIPING MUST BE INSULATED TO A MINIMUM OF R-3. HOT WATER PIPING 1/2 IN DIAMETER OR LARGER AND ALL HOT WATER PIPING IN CERTAIN APPLICATIONS MUST BE INSULATED TO
- 6.2. PIPES CARRYING FLUID OVER 104° OR BELOW 55° MUST BE INSULATED WITH R-13.
- 6.4. A MINIMUM OF 75% OF LAMPS IN PERMANENTLY INSTALLED FIXTURES MUST BE HIGH-EFFICACY AS DEFINED IN THE IECC.


ADOPTED CITY CODES:

- 2021 International Building Code
- 2021 International Residential Code
- 2021 International Energy Conversational Code
- 2021 International Fuel Gas Code
- 2021 International Mechanical Code 2021 International Plumbing Code
- 2021 International Existing Building Code
- 2021 International Fire Code
- 2020 National Electrical Code



Xavier Chapa Engineering/Surveyin Firm Number F-9156

12/16/2024

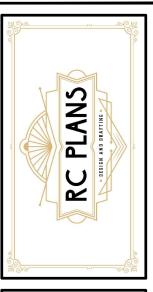


214-859-4267

THESE PLANS AND SPECIFICATIONS ARE INTENDED SOLELY FOR USE ON THE DESIGNATED SITE FOR WHICH THEY VERE CREATED. ANY REPRODUCTION OF WERE CREATED. ANY REPRODUCTION OR DISTRIBUTION IS STRICTLY CONFINED TO THIS PURPOSE. REPRODUCTION, REUSE, OR DISCLOSURE—WHETHER IN FULL OR PARTIAL FORM AND BY ANY MEANS—OUTSIDE OF THIS INTENDED USE IS PROHIBITED ROPLANS LLC RETAINS S PROHIBITED. ROPLANS LLC RETAINS OWNERSHIP AND PROPRIETARY RIGHTS TO THE INFORMATION CONTAINED WITHIN THESE DRAWINGS AND SPECIFICATIONS.

USE:	RESIDENTIAL NEW
	DUPLEX
	CONSTRUCTION
PLAN:	FLOOR PLAN
DRAWN BY:	RC PLANS
DATE:	11/18/2024
SCALE:	1/8" = 1'-0"


ADDRESS:

117 N VAN **BUREN** AVE, DALLAS, TX 75208

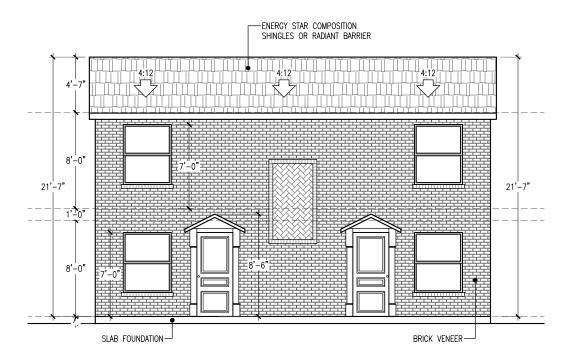


PROPOSED FRONT ELEVATION

SCALE 1/8" = 1'-0"

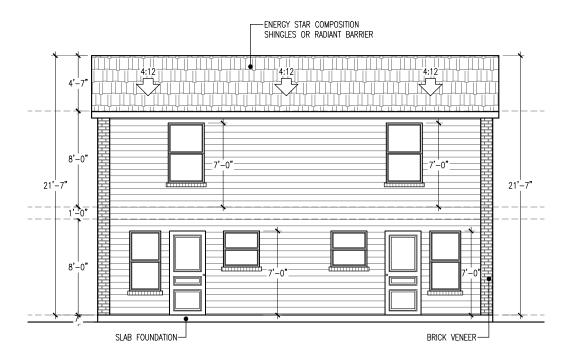


PROPOSED REAR ELEVATION

SCALE 1/8" = 1'-0"

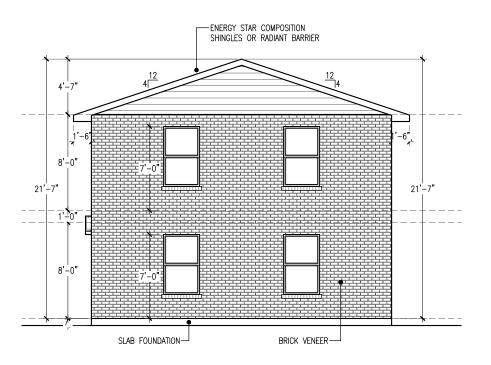

PROPOSED RIGHT ELEVATION

SCALE 1/8" = 1'-0"

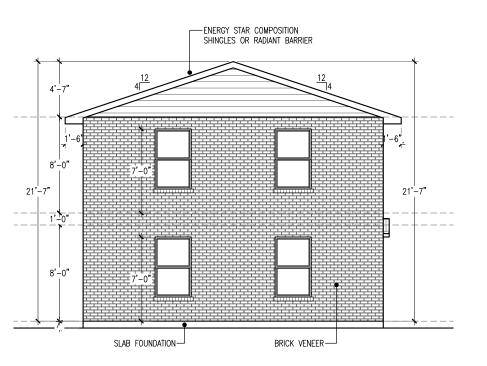

PROPOSED LEFT ELEVATION

SCALE 1/8" = 1'-0"



214-859-4267


THESE PLANS AND SPECIFICATIONS ARE INTENDED SOLELY FOR USE ON THE DESIGNATED SITE FOR WHICH THEY WERE CREATED. ANY REPRODUCTION OR DISTRIBUTION IS STRICTLY CONFINED TO THIS PURPOSE. REPRODUCTION, REUSE, OR DISCLOSURE—WHETHER IN FULL OR PARTIAL FORM AND BY ANY MEANS—OUTSIDE OF THIS INTENDED USE IS PROHIBITED. RCPLANS LLC RETAINS OWNERSHIP AND PROPRIETARY RIGHTS TO THE INFORMATION CONTAINED WITHIN THESE DRAWINGS AND SPECIFICATIONS.

USE:	RESIDENTIAL NEW DUPLEX
PLAN:	ELEVATION
DRAWN BY: RC PLANS	RC PLANS
DATE:	11/18/2024
SCALE:	1/8" = 1'-0"

ADDRESS:

117 N VAN BUREN AVE, DALLAS, TX 75208


PAGE NUMBER:

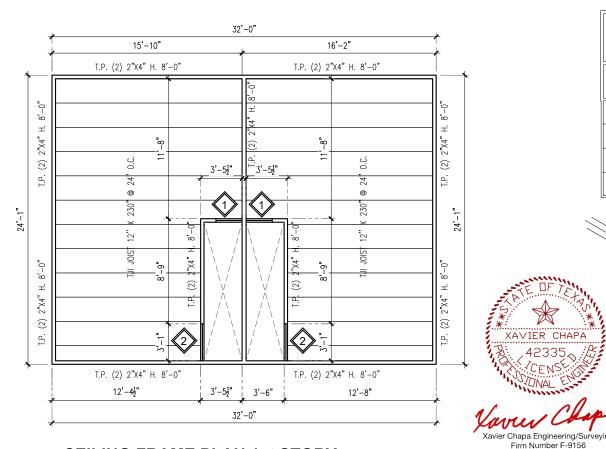


XAVIER CHAPA

.42335

12/16/2024

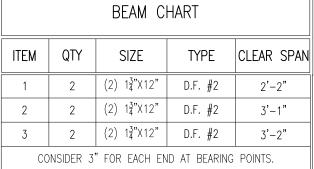

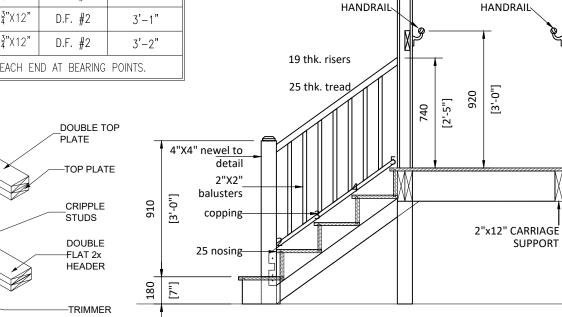

PLANS

214-859-4267

THESE PLANS AND SPECIFICATIONS ARE NTENDED SOLELY FOR USE ON THE DESIGNATED SITE FOR WHICH THEY WERE CREATED. ANY REPRODUCTION OF ISTRIBUTION IS STRICTLY CONFINED T JISTRIBUTION IS STRICLLY CONTINED I TO
THIS PURPOSE. REPRODUCTION, REUSE,
OR DISCLOSURE—WHETHER IN FULL OR
ARTIAL FORM AND BY ANY
MEANS—OUTSIDE OF THIS INTENDED USE
PROHIBITED ROPLANS LLC RETAINS
DWINERSHIP AND PROPRIETARY RIGHTS
TO THE NISTORMATION. CONTENDED WHETHER
THE NISTORMATION. CONTENDED WHETHER
THE NISTORMATION. CONTENDED WHETHER
TO THE NISTORMATION. CONTENDED WHETHER
THE NISTORMATION. CONTENDED WHEN
THE NISTORMATION. THE NISTORMATION
THE NISTORMATION. THE NISTORMATION
THE NISTORMATION. THE NISTORMATION
THE NISTORMATION. THE NISTORMATION
THE NISTO TO THE INFORMATION CONTAINED WITH HESE DRAWINGS AND SPECIFICATIONS.

USE:	RESIDENTIAL NEW DUPLEX
PLAN:	FRAMING PLAN
DRAWN BY:	RC PLANS
DATE:	11/18/2024
SCALE:	1/8" = 1'-0"


ADDRESS:

117 N VAN **BUREN** AVE, DALLAS, TX 75208

PAGE NUMBER:

CEILING FRAME PLAN 1st STORY

SCALE 1/8" = 1'-0"

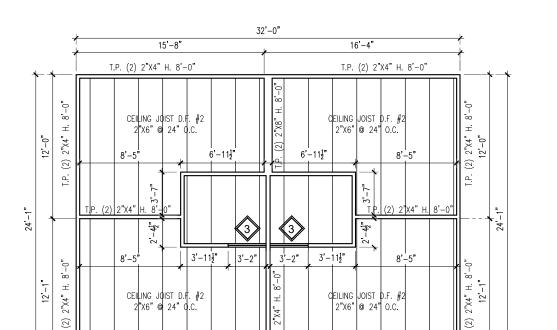

CEILING FRAME PLAN 2nd STORY

32'-0"


T.P. (2) 2"X4" H. 8'-0"

15'-10"

SCALE 1/8" = 1'-0"

T.P. (2) 2"X4" H. 8'-0"

16'-2"

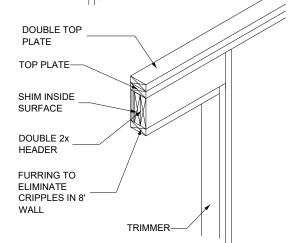

HEADER FRAMING DET.

TRUSS/ROOF RAFTER HURRICANE STRAP TOP PLATE INSTALL HALF OF FASTENERS @ EACH END OF STRAP


RAFTER HURRICANE TIE DET.

V.R. VALLEY RAFTER HIP RAFTER H.R. L.B. LEDGER BOARD R. COMMON RAFTER C.J. **CEILING JOIST** T.P. TOP PLATE HDR. HEADER

NOTE

RIDGE BOARD

HEIGHT

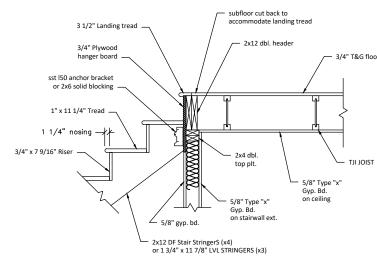

STAIRS LANDING DET.

R.B.

Н.


STAIRS FRAMING DET.


N.T.S.

1010

[3'-4"]

SUPPORT

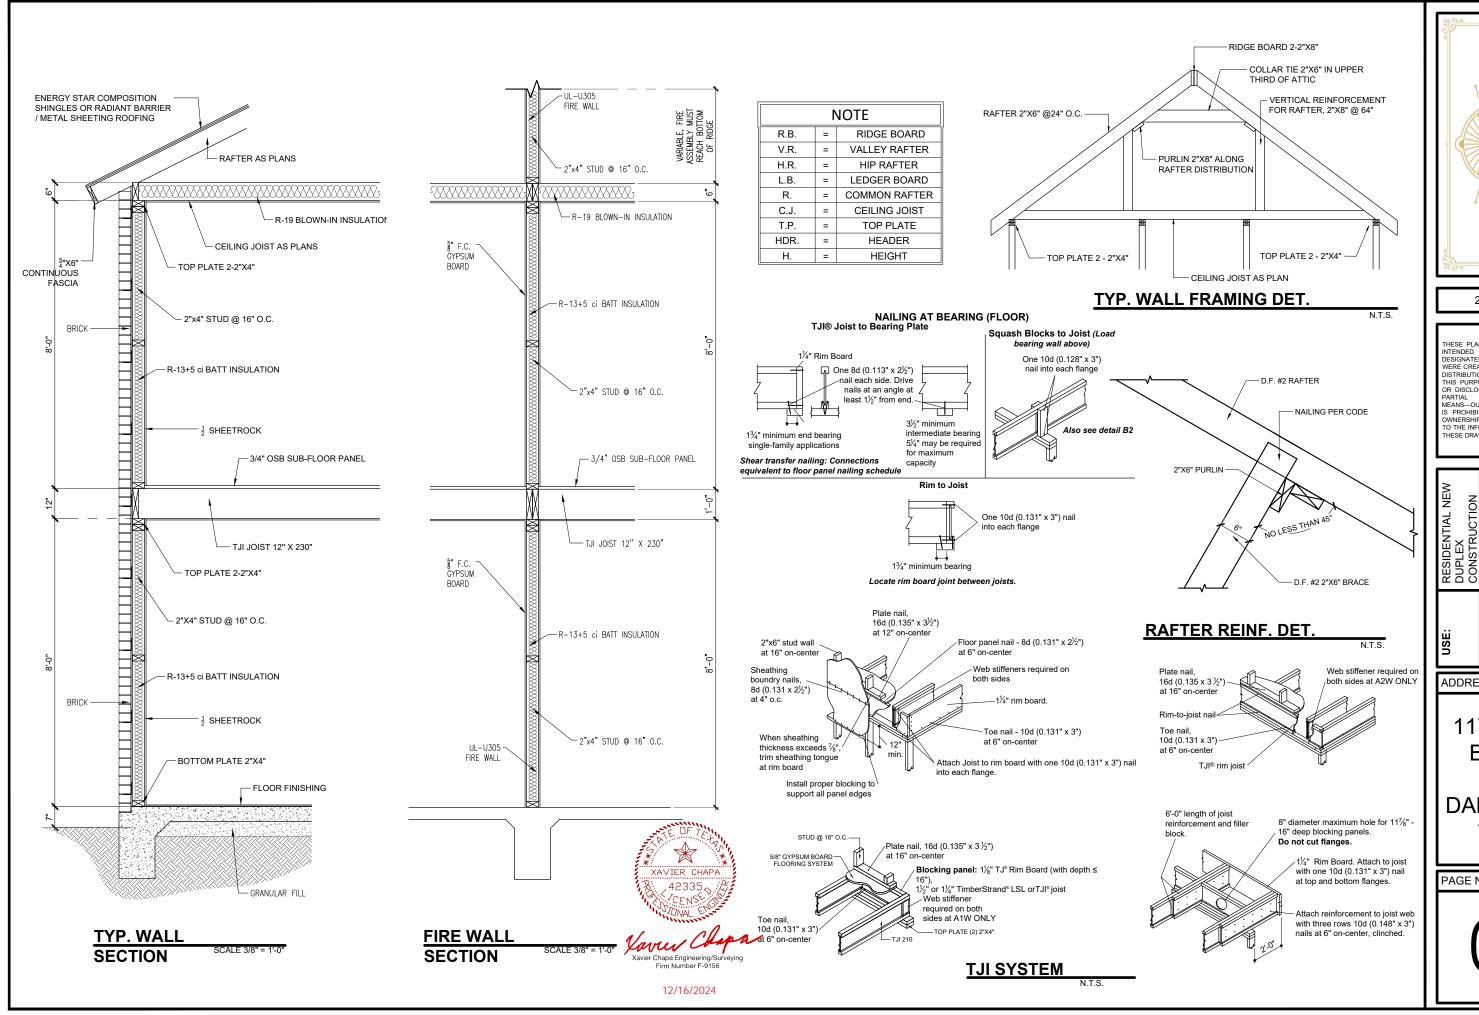

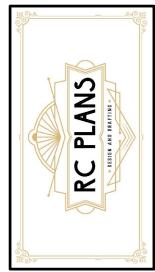


214-859-4267

HESE PLANS AND SPECIFICATIONS ARE ITENDED SOLELY FOR USE ON THE ESIGNATED SITE FOR WHICH THEY VERE CREATED. ANY REPRODUCTION OR ISTRIBUTION IS STRICTLY CONFINED T JISTRIBUTION IS STRICLLY CONTINED I TO
THIS PURPOSE. REPRODUCTION, REUSE,
OR DISCLOSURE—WHETHER IN FULL OR
ARTIAL FORM AND BY ANY
MEANS—OUTSIDE OF THIS INTENDED USE
PROHIBITED ROPLANS LLC RETAINS
DWINERSHIP AND PROPRIETARY RIGHTS
TO THE NISTORMATION. CONTENDED WHETHER
THE NISTORMATION. CONTENDED WHETHER
THE NISTORMATION. CONTENDED WHETHER
TO THE NISTORMATION. CONTENDED WHETHER
THE NISTORMATION. CONTENDED WHEN
THE NISTORMATION. THE NISTORMATION
THE NISTORMATION. THE NISTORMATION
THE NISTORMATION. THE NISTORMATION
THE NISTORMATION. THE NISTORMATION
THE NISTO TO THE INFORMATION CONTAINED WITH HESE DRAWINGS AND SPECIFICATIONS.

USE:	RESIDENTIAL NEW DUPLEX
	CONSTRUCTION
PLAN:	FRAMING PLAN
DRAWN BY:	RC PLANS
DATE:	11/18/2024
SCALE:	1/8" = 1'-0"


ADDRESS:

117 N VAN **BUREN** AVE, DALLAS, TX 75208

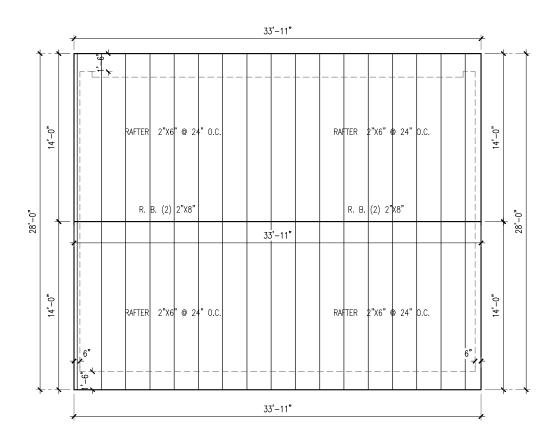

ROOF FRAMING PLAN

SCALE 1/8" = 1'-0"

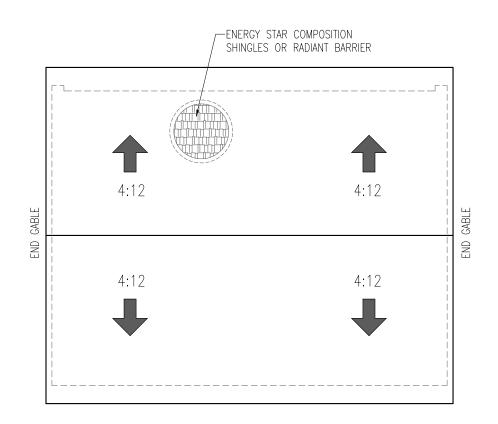

ROOF PLAN


N.T.S.


HEADER SPAN TABLE

SINGLE STORY	TWO STORY
4"X4"	6"X6"
4"X6"	6"X8"
4"X8"	6"X10"
4"X10"	6"X12"
4"X12"	6"X14"
	4"X4" 4"X6" 4"X8" 4"X10"

MAXIMUM STUD HEIGHT TABLE

STUD HEIGHT BEARING WALL NON-BEARING WALL 0' TO 10' 2"X6" 2"X4"

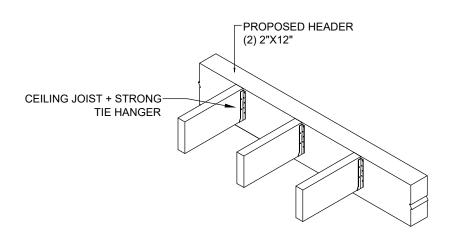

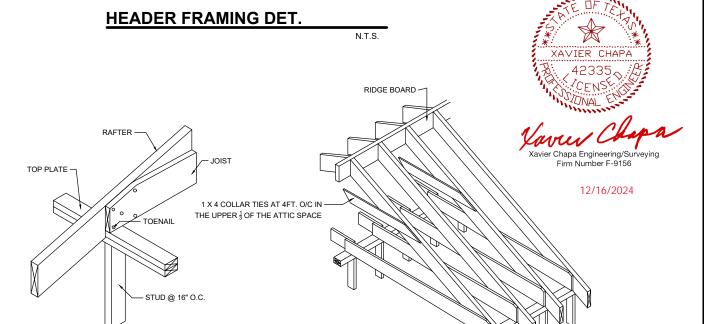

RAFTER BRACE DET.

TS

CONTINUOUS TIE BY CEILING JOIST



214-859-4267


THESE PLANS AND SPECIFICATIONS ARE INTENDED SOLELY FOR USE ON THE DESIGNATED SITE FOR WHICH THEY WERE CREATED. ANY REPRODUCTION OR DISTRIBUTION IS STRICTLY CONFINED TO THIS PURPOSE. REPRODUCTION, REUSE, OR DISCLOSURE—WHETHER IN FULL OR PARTIAL FORM AND BY ANY MEANS—OUTSIBE OF THIS INTENDED USE IS PROHIBITED. RCPLANS LLC RETAINS OWNERSHIP AND PROPRIETARY RIGHTS TO THE INFORMATION CONTAINED WITHIN THESE DRAWINGS AND SPECIFICATIONS.

USE:	RESIDENTIAL NEW DUPLEX
	CONSTRUCTION
PLAN:	FRAMING PLAN
DRAWN BY:	RC PLANS
DATE:	11/18/2024
SCALE:	1/8" = 1'-0"

ADDRESS:


117 N VAN BUREN AVE, DALLAS, TX 75208

PAGE NUMBER:

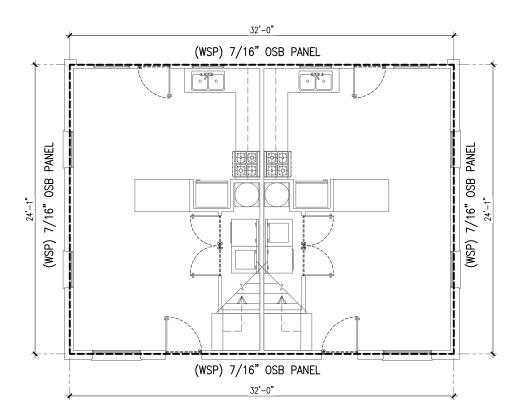

WALL BRACING PLAN 1st. STORY

SCALE 1/8" = 1'-0"

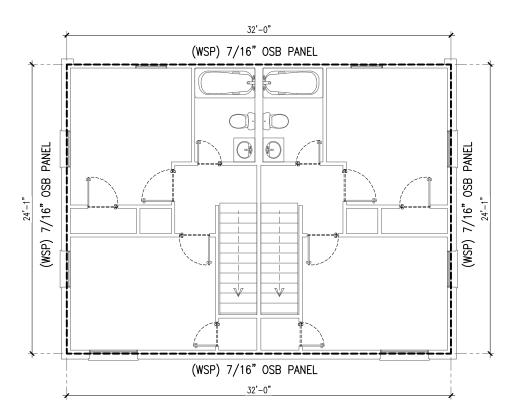

WALL BRACING PLAN 2nd. STORY

SCALE 1/8" = 1'-0"

SECTION R403.1.6:

Wood sole plates at all exterior walls on monolithic slabs, wood sole plates of braced wall panels at building interiors on monolithic slabs and all wood sill plates shall be anchored to the foundation with minimum 1/2-inch-diameter (12.7 mm) anchor bolts spaced a maximum of 6 feet (1829 mm) on center or approved anchors or anchor straps spaced as required to provide equivalent anchorage to 1/2-inch-diameter (12.7 mm) anchor bolts. Bolts shall extend a minimum of 7 inches (178 mm) into concrete or grouted cells of concrete masonry units. The bolts shall be located in the middle third of the width of the plate. A nut and washer shall be tightened on each anchor bolt. There shall be a minimum of two bolts per plate section with one bolt located not more than 12 inches (305 mm) or less than seven bolt diameters from each end of the plate section. Interior bearing wall sole plates on monolithic slab foundation that are not part of a braced wall panel shall be positively anchored with approved fasteners. Sill plates and sole plates shall be protected against decay and termites where required by Sections R317 and

SECTION R602.10.5

Continuous Wood Structural Panel Sheathing

When continuous wood structural panel sheathing is provided in accordance with Method 3 of Section R602.10.3 on all sheathable areas of all exterior walls, and interior braced wall lines, where required, including areas above and below openings, bracing wall panel lengths shall be in accordance with Table R602.10.5. Wood structural panel sheathing shall be installed at corners in accordance with Figure R602.10.5. The bracing amounts in Table R602.10.1 for Method 3 shall be permitted to be multiplied by a factor of 0.9 for wall with a maximum opening height that does not exceed 85 percent of the wall height or a factor of 0.8 for walls with a maximum opening height that does not exceed 67 percent of the wall height.

LENGTI		'S FOR BRACED LY SHEATHED W	WALL PANELS IN A /ALLa, b, c	
MINIMUM LEN	IGTH OF BRACED (inches)	WALL PANEL	MAXIMUM OPENING HEIGHT NEXT TO THE BRACED WALL	
8-foot wall	9-foot wall	10-foot wall	PANEL (% of wall height)	
48	54	60	100	
32	36	40	85	
24	27	30	65	

For SI: 1 inch = 25.4 mm, 1 foot = 305 mm, 1 pound per square foot = 0.0479 kPa.

a. Linear interpolation shall be permitted.

b. Full-height sheathed wall segments to either side of garage openings that support light frame roofs only, with roof covering dead loads of 3 psf or less shall be permitted to have a 4:1 aspect ratio.

c. Walls on either or both sides of openings in garages attached to fully sheathed dwellings shall be permitted to be built in accordance with Section R602.10.6.2 and Figure R602.10.6. except that a single bottom plate shall be permitted and two anchor bolts shall be placed at 1/3 points. In addition, tie-down devices shall not be required and the vertical wall segment shall have a maximum 6:1 height-to-width ratio (with height being measured from top of header to the bottom of the sill plate). This option shall be permitted for the first story of two-story applications in Seismic Design Categories A through C.

R602.10.6.1 Alternate Braced Wall Panels

Alternate braced wall lines constructed in accordance with one of the following provisions shall be permitted to replace each 4 feet (1219 mm) of braced wall panel as required by Section R602.10.4. The maximum height and minimum width of each panel shall be in accordance with Table R602.10.6:

In one-story buildings, each panel shall be sheathed on one face with 3/8-inch minimum-thickness (10 mm) wood structural panel sheathing nailed with 8d common or galvanized box nails in accordance with Table R602.3(1) and blocked at all wood structural panel sheathing edges. Two anchor bolts installed in accordance with Figure R403.1(1) shall be provided in each panel. Anchor bolts shall be placed at panel quarter points. Each panel end stud shall have a tie-down device fastened to the foundation, capable of providing an uplift capacity in accordance with Table R602.10.6. The tie down device shall be installed in accordance with the manufacturer's recommendations. The panels shall be supported directly on a foundation or on floor framing supported directly on a foundation which is continuous across the entire length of the braced wall line. This foundation shall be reinforced with not less than one No. 4 bar top and bottom. When the continuous foundation is required to have a depth greater than 12 inches (305 mm), a minimum 12-inch by 12-inch (305 mm by 305 mm) continuous footing or turned down slab edge is permitted at door openings in the braced wall line. This continuous footing or turned down slab edge shall be reinforced with not less than one No. 4 bar top and bottom. This reinforcement shall be lapped 15 inches (381 mm) with the reinforcement required in the continuous foundation located directly under the braced wall

In the first story of two-story buildings, each braced wall panel shall be in accordance with Item 1 above, except that the wood structural panel sheathing shall be installed on both faces, sheathing edge nailing spacing shall not exceed 4 inches (102 mm) on center, at least three anchor bolts shall be placed at one-fifth points.

R602.10.6.2 Alternate Braced Wall Panel Adjacent to a Door or Window Opening Alternate braced wall panels constructed in accordance with one of the following provisions are also permitted to replace each 4 feet (1219 mm) of braced wall panel as required by Section R602.10.4 for use adjacent to a window or door opening with a full-length header:

In one-story buildings, each panel shall have a length of not less than 16 inches (406 mm) and a height of not more than 10 feet (3048 mm). Each panel shall be sheathed on one face with a single layer of 3/8-inch minimum-thickness (10 mm) wood structural panel sheathing nailed with 8d common or galvanized box nails in accordance with Figure R602.10.6.2. The wood structural panel sheathing shall extend up over the solid sawn or glued-laminated header and shall be nailed in accordance with Figure R602.10.6.2. Use of a built-up header consisting of at least two 2 x 12s and fastened in accordance with Table R602.3(1) shall be permitted. A spacer, if used, shall be placed on the side of the built-up beam opposite the wood structural panel sheathing. The header shall extend between the inside faces of the first full-length outer studs of each panel. The clear span of the header between the inner studs of each panel shall be not less than 6 feet (1829 mm) and not more than 18 feet (5486 mm) in length. A strap with an uplift capacity of not less than 1000 pounds (4448 N) shall fasten the header to the side of the inner studs opposite the sheathing. One anchor bolt not less than 5/8-inch diameter (16 mm) and installed in accordance with Section R403.1.6 shall be installed in the center of each sill plate. The studs at each end of the panel shall have a tie-down device fastened to the foundation with an uplift capacity of not less than 4,200 pounds (18 683 N).

Where a panel is located on one side of the opening, the header shall extend between the inside face of the first full—length stud of the panel and the bearing studs at the other end of the opening. A strap with an uplift capacity of not less than 1000 pounds (4448 N) shall fasten the header to the bearing studs. The bearing studs shall also have a tie—down device fastened to the foundation with an uplift capacity of not less than 1000 pounds (4448 N).

The tie-down devices shall be an embedded-strap type, installed in accordance with the manufacturer's recommendations. The panels shall be supported directly on a foundation which is continuous across the entire length of the braced wall line. The foundation shall be reinforced with not less than one No. 4 bar too and bottom.

Where the continuous foundation is required to have a depth greater than 12 inches (305 mm), a minimum 12—inch by 12—inch (305 mm by 305 mm) continuous footing or turned down slab edge is permitted at door openings in the braced wall line. This continuous footing or turned down slab edge shall be reinforced with not less than one No. 4 bar top and bottom. This reinforcement shall be lapped not less than 15 inches (381 mm) with the reinforcement required in the continuous foundation located directly under the braced wall line. In the first story of two—story buildings, each wall panel shall be braced in accordance with Item 1 above, except that each panel shall have a length of not less than 24 inches (610 mm).

METHOD WSP: WOOD STRUCTURAL PANEL	EDGE NAIL COMMON 6 FIELD NAIL 6D COMMON 12" (STRUCTURAL	" O.C.
\mathbb{A}	STRUCTURAL PANEL SHEATHING	

XAVIER CHAPA

Firm Number F-9156

12/16/2024

REQUIREMENTS FOR WOOD STRUCTURAL PANEL WALL SHEATHING USED TO RESIST WIND PRESSURES

NESIST WIND FRESSURES									
MINIMU	M NAIL	MINIMUM WOOD STRUCTURAL	MINIMUM NOMINAL PANEL THICKNESS	MAXIMUM WALL STUD SPACING	PANEL NAI	L SPACING	ULTIMATE	DESIGN WIND SPE	ED (mph)
SIZE	PENETRATION	PANEL SPAN RATING	(INCHES)	(INCHES)	EDGES (INCHES	FIELD (INCHES	WINI	D EXPOSURE CATEG	ORY
SIZE	(INCHES)				0.C.)	0.C.)	В	С	D
6d Common (2.0" x 0.113")	1.5	24/0	3/8	16	6	12	140	115	110
8d Common (2.5"	1.75	24/16	7/16	16	6	12	170	140	135
x 0.131")	1.75	21,10	,,,,,	16	6	12	140	115	110



214-859-4267


THESE PLANS AND SPECIFICATIONS ARE INTENDED SOLELY FOR USE ON THE DESIGNATED SITE FOR WHICH THEY WERE CREATED. ANY REPRODUCTION OR DISTRIBUTION IS STRICTLY CONFINED TO THIS PURPOSE. REPRODUCTION, REUSE, OR DISCLOSURE—WHETHER IN FULL OR PARTIAL FORM AND BY ANY MEANS—OUTSIDE OF THIS INTENDED USE IS PROHIBITED. RCPLANS LIC RETAINS OWNERSHIP AND PROPRIETARY RIGHTS TO THE INFORMATION CONTAINED WITHIN THESE DRAWINGS AND SPECIFICATIONS.

USE:	RESIDENTIAL NEW
	DUPLEX
	CONSTRUCTION
PLAN:	WALL BRACING
	PLAN
DRAWN BY:	RC PLANS
DATE:	11/18/2024
SCALE:	1/8" = 1'-0"


ADDRESS:

117 N VAN BUREN AVE, DALLAS, TX 75208

PAGE NUMBER:

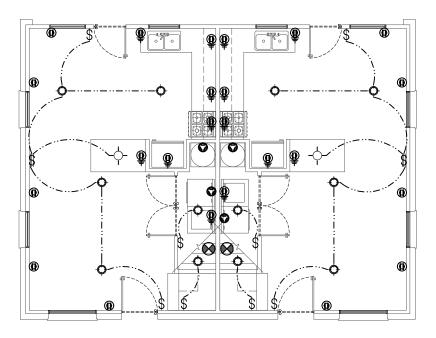

ELECTRICAL PLAN 1st STORY SCALE 1/8" = 1'-0"

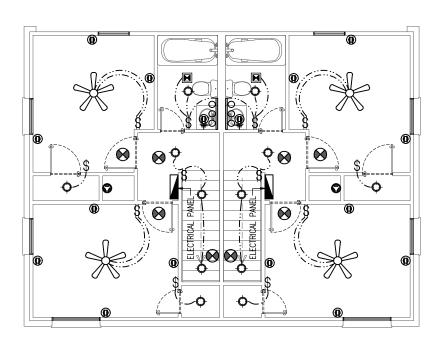

ELECTRICAL PLAN 2nd STORY SCALE 1/8" = 1'-0"

ELECTRICAL FIXTURE		
FIXTURE	HEIGHT	
STANDARD OUTLET	15"	
OUTLET AT 30" CAB.	30"	
OUTLET AT 36" CAB.	48"	
TYPICAL WALL SWITCH	48"	×
FRIDGE OUTLET	60"	
GARAGE OUTLET	48"	
UTILITY OUTLET	42"	

ELECTRICAL LEGEND			
BREAKERS PANEL			
CEILING MOUNTED LIGHT	ф		
110 VOLT RECEPTACLE	(D)		
220 VOLT RECEPTACLE	0		
EXHAUST FAN (50 cfm MIN.)	×		
SMOKE DETECTOR W/ CARBON MONOXIDE DETECTION (HARD WIRE WITH BATTERY BACKUP)	8		
SINGLE SWITCH	\$		
DOUBLE SWITCH	\$		
3 WAY SWITCH	\$3way		
WALL MOUNTED LIGHT	٨		
ELECTRICAL WIRE			
110 VOLT RECEPTACLE GROUND FAULT INTERRUPTER	@		
GARAGE DOOR OPENER	®		
INCANDESCENT LIGHT TUBE			
CEILING FAN W/OPT. LIGHT	*		
CEILING PENDANT LIGHT	- ∳-		
OUTDOOR WALL LIGHT	Ð		
VANITY LIGHTS	000		
110 VOLT EXTERIOR RECEPTACLE GROUND FAULT INTERRUPTER	@		




214-859-4267

THESE PLANS AND SPECIFICATIONS ARE INTENDED SOLELY FOR USE ON THE DESIGNATED SITE FOR WHICH THEY WERE CREATED, ANY REPRODUCTION OR DISTRIBUTION IS STRICTLY CONFINED TO THIS PURPOSE, REPRODUCTION, REUSE, OR DISCLOSURE—WHETHER IN FULL OR PARTIAL FORM AND BY ANY MEANS—OUTSIBLE OF THIS INTENDED USE IS PROHIBITED, RCPLANS LLC RETAINS OWNERSHIP AND PROPRIETARY RIGHTS TO THE INFORMATION CONTAINED WITHIN THESE DRAWINGS AND SPECIFICATIONS.

USE:	RESIDENTIAL NEW
	DUPLEX
	CONSTRUCTION
PLAN:	ELECTRICAL PLAN
DRAWN BY:	RC PLANS
DATE:	11/18/2024
SCALE	1/8" = 1'-0"

ADDRESS:


117 N VAN **BUREN** AVE, DALLAS, TX 75208

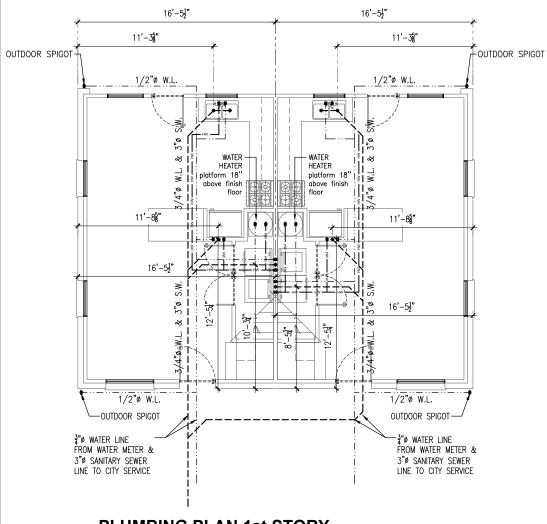

PLUMBING--PILIMBING RISER FROM RISER FROM FIRST STORY FIRST STORY

PLUMBING PLAN 2nd STORY


PLUMBING PLAN 1st STORY

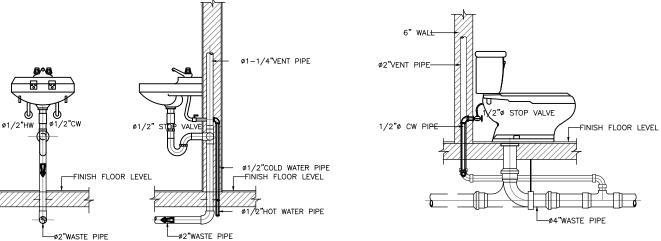

WATE	R CLOS	ET D	ETAIL
			0041

PLUMBING LEGEND		
ABBREVIATION	DESCRIPTION	
P.W.	PLUMBING WALL	
S.W.	SANITARY SEWER LINE	
W.L.	WATER LINE	

PLUMBING LEGEND		
SYMBOL	DESCRIPTION	
	COLD WATER LINE	
	HOT WATER LINE	
	SANITARY SEWER LINE	
	FIXTURE	
WH	WATER HEATER	
▼ VP	VENT. PIPE	
\rightarrow	SANITARY CONNECTION	

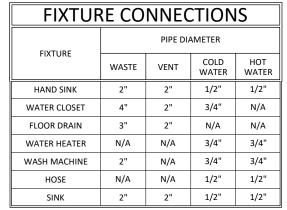


NOTES:
1. SIZES SHOWN ARE MINIMUM UNIFORM PLUMBING CODE REQUIREMENTS
2012 PROJECT IN COMMECTION


FOR TRAPS, TRAP ARM & ROUGH-IN CONNECTION.

2. IF CAST IRON NO-HUB PIPE IS USED, WASTE AND VENT PIPE SHALL BE 2" MINIMUM.

COLD WASHING MACHINE ROUGH-IN UNIT HOSE BIBB SUPPLY FITTINGS 2" STAND PIPE 12" x 12" ACCESS PANEL 1-1/2" VENT 2" DRAIN TO FINISHED SAN. SEWER FLOOR-2" P-TRAP - CLEANOUT **LAUNDRY DETAIL**

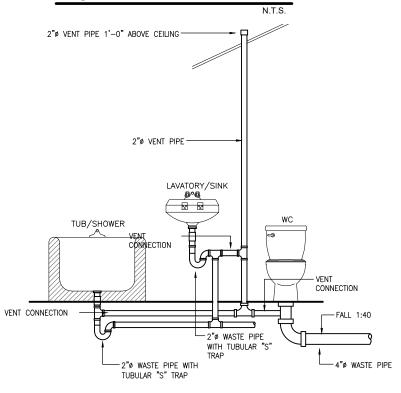

PLUMBING RAISER DETAIL

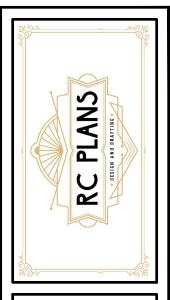

214-859-4267


THESE PLANS AND SPECIFICATIONS ARE THESE PLANS AND SPECIFICATIONS ARE INTENDED SOLELY FOR USE ON THE DESIGNATED SITE FOR WHICH THEY WERE CREATED ANY REPRODUCTION OR DISTRIBUTION IS STRICTLY CONFINED TO THIS PURPOSE REPRODUCTION, REUSE, OR DISCLOSURE—WHETHER IN FULL OR PARTIAL FORM AND BY ANY MEANS—OUTSIDE OF THIS INTENDED USE IS PROHIBITED. RCPLANS LLC RETAINS OWNERSHIP AND PROPRIETARY RIGHTS TO THE INFORMATION CONTAINED WITHIN THESE DRAWINGS AND SPECIFICATIONS.

USE:	RESIDENTIAL NEW DUPLEX
PI AN:	
DRAWN BY:	RC PLANS
DATE:	11/18/2024
SCALE.	1/8" = 1'-0"

ADDRESS:

117 N VAN **BUREN** AVE, DALLAS, TX 75208


PAGE NUMBER:

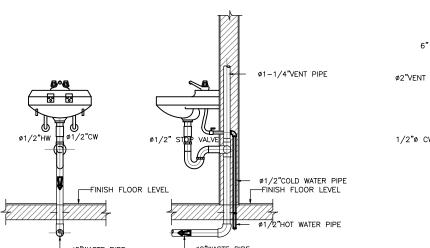

SCALE 3/8" = 1'-0"

HAND SINK DETAIL

SCALE 3/8" = 1'-0"

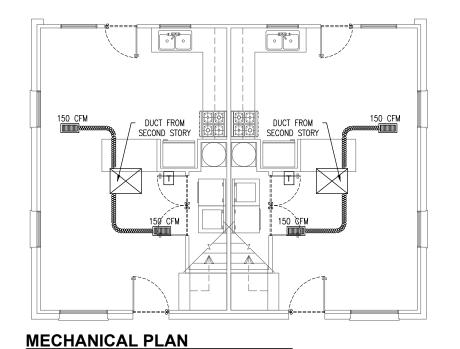

SCALE 1/8" = 1'-0"

MECHANICAL LEGEND		
SYMBOL	DESCRIPTION	
	GAS LINE	
•	FLEXIBLE R-8 INSULATED DUCT	
	UNDERCUT DOOR	
	BATHROOM EXHAUST	
	NEW SUPPLY DIFFUSER	
Ī	THERMOSTAT	
F	NEW RETURN ON CEILING	

DUCTWORK		
DIAMETER	AIR FLOW CFM	
4	20	
5	50	
6	80	
7	120	
8	170	
9	230	
10	300	
12	500	
14	740	
16	1050	
18	1400	
20	1875	

GENERAL MECHANICAL NOTES:

- CONTRACTOR SHALL BE RESPONSIBLE TO PROVIDE LABOR AND MATERIALS NECESSARY TO PROVIDE A COMPLETE AND WORKING HVAC SYSTEM IN COMPLIANCE WITH THE CURRENT CITY CODES.
- DUCTWORKS SHALL BE CONSTRUCTED AND INSTALLED WITH ASHRAE AND SMACNA STANDARDS AND STATE MECHANICAL CODE. THIS INCLUDES (BUT IS NOT LIMITED TO) SEALING ALL DUCTS, SPLITTERS (OR SIMILAR. BALANCING DEVICES) AT MAJOR DUCTWORK BRANCHES, EXTRACTORS AT MINOR DUCTWORKS BRANCHES,. DOUBLE WALLED ACOUSTIC TURNING VANES IN ELBOWS, SPLITTERS AND TURNING VANES IN TEES.
- ALL DUCTWORK SHALL BE GALVANIZED SHEETMETAL, RECTANGULAR DUCT SHALL BE INTERNALLY LINED WITH 1", 1-1/2" DUCT LINER, ROUND DUCT SHALL. BE WRAPPED WITH 1-1/2" INSULATION (EXCEPT WHERE EXPOSED), FLEX. DUCT SHALL BE INSULATED TYPE.
- THE MECHANICAL SYSTEMS SHALL BE. TESTED. ADJUSTED. AND BALANCED BY A BALACING FIRM SPECIALIZING IN. THIS TYPE OF WORK. TESTS SHALL

DETERMINE QUANTITATIVE PERFORMANCE OF EQUIPMENT; BALANCING PROPORTION FLOWS WITHIN THE DISTRIBUTION SYSTEM ACCORDING TO SPECIFIED DESIGN QUANTITIES. ALL WORK SHALL MEET LOCAL CODES AND STANDARDS, NEBB AND ASHRAE TESTING, ADJUSTING BALANCING PROCEDURES, SUBMIT THE BUILDING OWNER FOR REVIEW, APPROVAL AND RECORD TWO COPIES OF THE BALANCING REPORTS ON THE STANDARD REPORT FORMS.

DRAWINGS ARE DIAGRAMMATIC AND INDICATE GENERAL ARRANGEMENT OF WORK AND EQUIPMENT.


ALL ROOF MODIFICATIONS, REPAIRS, CUTTING. FLASHING. COUNTERFLASHING, PENETRATION, AND CURB INSTALLATIONS SHALL BE ENGINEERED AND INSTALLATION TO BE PERFORMED CONTRACTOR.

ALL ROOF CAPS SHALL BE COMPLETE WITH BIRDSCREEN

SEAL ALL PENETRATIONS THRU WALLS, FLOORS AND CEILINGS.


COORDINATE ROUTING OF DUCTWORK WITH STRUCTURAL. ALL DUCTWORK TO BE FLEXIBLE,

DIAMETER ACCORDING TO CFM DEMAND.

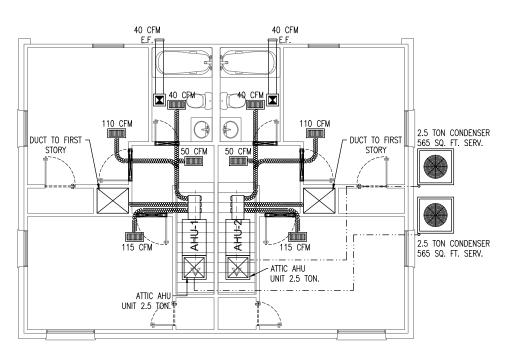


MECHANICAL PLAN 2d. STORY

1st. STORY

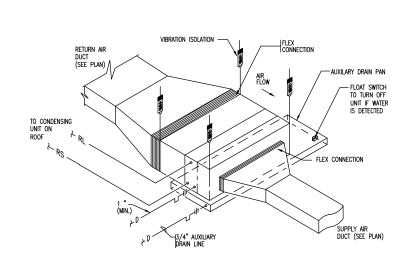

HORIZONTAL AIR HANDLING UNIT WITH DUCTED DISCHARGE AND RETURN

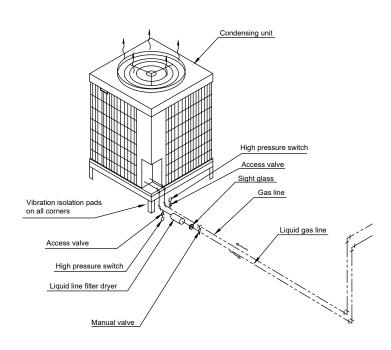

CONDENSING UNIT INSTALLATION

PLANS


214-859-4267

THESE PLANS AND SPECIFICATIONS ARE THESE PLANS AND SPECIFICATIONS ARE INTENDED SOLELY FOR USE ON THE DESIGNATED SITE FOR WHICH THEY WERE CREATED, ANY REPRODUCTION OR DISTRIBUTION IS STRICTLY CONFINED TO THIS PURPOSE. REPRODUCTION, REUSE, I FIIS TOWNOSE. REPRODUCTION, REUSE, OR DISCLOSURE—WHETHER IN FULL OR PARTIAL FORM AND BY ANY MEANS—OUTSIDE OF THIS INTENDED USE IS PROHIBITED. RCPLANS LLC. RETAINS OWNERSHIP AND PROPRIETARY RIGHTS TO THE INFORMATION CONTAINED WITHIN THE INFORMATION CONTAINED WITHIN THE DEPARTMENT OF THE INFORMATION CONTAINED WITHIN THE PER DRAWINGS AND SEPCIFICATIONS. HESE DRAWINGS AND SPECIFICATIONS

USE:	RESIDENTIAL NEW DUPLEX CONSTRUCTION
PLAN:	MECHANICAL PLAN
DRAWN BY: RC PLANS	RC PLANS
DATE:	11/18/2024
SCALE:	1/8" = 1'-0"

ADDRESS:

117 N VAN **BUREN** AVE, DALLAS, TX 75208

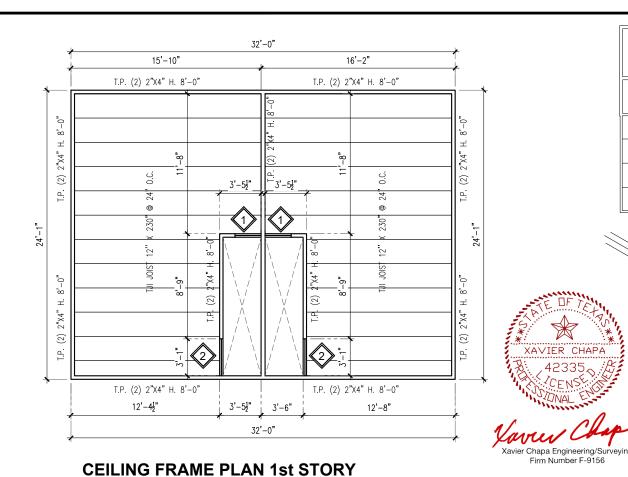

32'-0"

15'-8"

CEILING JOIST D.F. #2 2"X6" @ 24" O.C.

CEILING JOIST D.F. #2 2"X6" @ 24" O.C.

T.P. (2) 2"X4" H. 8'-0"

15'-10"

6'-11<u>1</u>"

T.P. (2) 2"X4" H. 8'-0"


2"X4" H. 8'-

(2)

2"X4" H.

T.P. (2)


BEAM CHART QTY SIZE TYPE CLEAR SPAN ITEM (2) $1\frac{3}{4}$ "X12" D.F. #2 2'-2" (2) $1\frac{3}{4}$ "X12" D.F. #2 3'-1" 2 (2) $1\frac{3}{4}$ "X12" 3 2 D.F. #2 3'-2" CONSIDER 3" FOR EACH END AT BEARING POINTS.

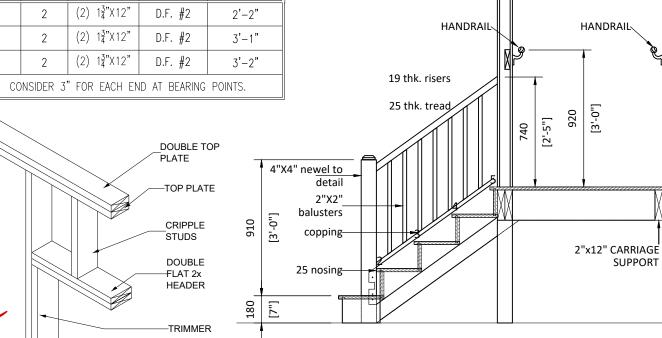

STAIRS FRAMING DET.

1010

[3'-4"]

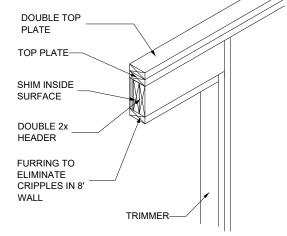

subfloor cut back to accommodate landing tread 3 1/2" Landing tread 2x12 dbl. header 3/4" Plywood or 2x6 solid blocking 1" x 11 1/4" Tread 1 1/4" nosing top plt. 5/8" Type "x" Gyp. Bd. 5/8" Type "x" Gyp. Bd. on ceiling 5/8" gyp. bd. 2x12 DF Stair StringerS (x4) or 1 3/4" x 11 7/8" LVL STRINGERS (x3)

HEADER FRAMING DET.

STAIRS LANDING DET.

N.T.S.

	TRUSS/ROOF RAFTER
HURRICANE STRAP TOP PLATE	CEILING JOIST
14-10d (TOTAL)	INSTALL HALF OF FASTENERS @ EACH END OF STRAP

	NOTE				
ľ	R.B.	=	RIDGE BOARD		
	V.R.	=	VALLEY RAFTER		
	H.R.	=	HIP RAFTER		
	L.B.	=	LEDGER BOARD		
	R.	=	COMMON RAFTER		
	C.J.	=	CEILING JOIST		
	T.P.	=	TOP PLATE		
	HDR.	=	HEADER		
	H.	=	HEIGHT		

CEILING FRAME PLAN 2nd STORY

32'-0"

SCALE 1/8" = 1'-0"

(2)

SCALE 1/8" = 1'-0"

16'-4"

CEILING JOIST D.F. # 2"X6" @ 24" O.C.

deiling Joist b.f. #2 2"X6" @ 24" O.C.

16'-2"

T.P. (2) 2"X4" H. 8'-0"

 $6'-11\frac{1}{2}"$


3'-11]"

3'-2"

T.P. (2) 2"X4" H. 8'-0"

12/16/2024

RAFTER HURRICANE TIE DET.

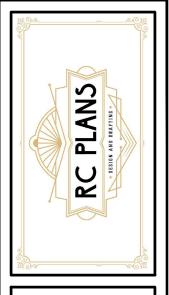


214-859-4267

THESE PLANS AND SPECIFICATIONS ARE NTENDED SOLELY FOR USE ON THE DESIGNATED SITE FOR WHICH THEY WERE CREATED. ANY REPRODUCTION OF ISTRIBUTION IS STRICTLY CONFINED T JISTRIBUTION IS STRICLLY CONTINED I TO
THIS PURPOSE. REPRODUCTION, REUSE,
OR DISCLOSURE—WHETHER IN FULL OR
ARTIAL FORM AND BY ANY
MEANS—OUTSIDE OF THIS INTENDED USE
PROHIBITED ROPLANS LLC RETAINS
DWINERSHIP AND PROPRIETARY RIGHTS
TO THE NISTORMATION. CONTENDED WHETHER
THE NISTORMATION. CONTENDED WHETHER
THE NISTORMATION. CONTENDED WHETHER
TO THE NISTORMATION. CONTENDED WHETHER
THE NISTORMATION. CONTENDED WHEN
THE NISTORMATION. THE NISTORMATION
THE NISTORMATION. THE NISTORMATION
THE NISTORMATION. THE NISTORMATION
THE NISTORMATION. THE NISTORMATION
THE NISTO TO THE INFORMATION CONTAINED WITH HESE DRAWINGS AND SPECIFICATIONS.


USE:	RESIDENTIAL NEW DUPLEX
PLAN:	FRAMING PLAN
DRAWN BY:	RC PLANS
DATE:	11/18/2024
SCALE:	1/8" = 1'-0"

ADDRESS:

117 N VAN **BUREN** AVE, DALLAS, TX 75208

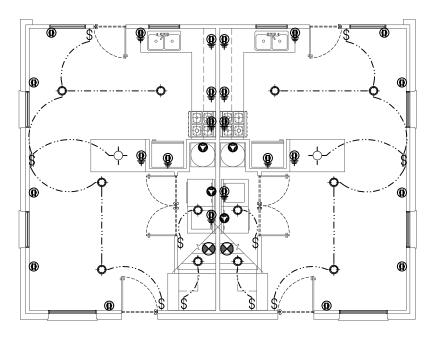


ELECTRICAL PLAN 1st STORY SCALE 1/8" = 1'-0"

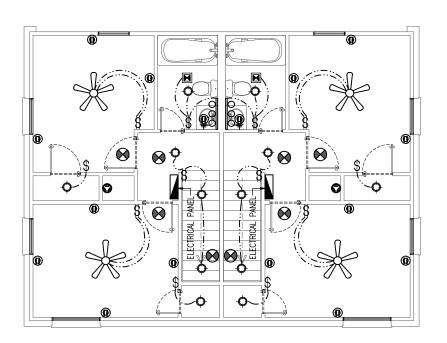

ELECTRICAL PLAN 2nd STORY SCALE 1/8" = 1'-0"

ELECTRICAL FIXTURE	S HEIGHT	
FIXTURE	HEIGHT	
STANDARD OUTLET	15"	
OUTLET AT 30" CAB.	30"	
OUTLET AT 36" CAB.	48"	
TYPICAL WALL SWITCH	48"	×
FRIDGE OUTLET	60"	
GARAGE OUTLET	48"	
UTILITY OUTLET	42"	

ELECTRICAL LI	EGEND
BREAKERS PANEL	
CEILING MOUNTED LIGHT	ф
110 VOLT RECEPTACLE	(D)
220 VOLT RECEPTACLE	0
EXHAUST FAN (50 cfm MIN.)	×
SMOKE DETECTOR W/ CARBON MONOXIDE DETECTION (HARD WIRE WITH BATTERY BACKUP)	8
SINGLE SWITCH	\$
DOUBLE SWITCH	\$
3 WAY SWITCH	\$3way
WALL MOUNTED LIGHT	Δ.
ELECTRICAL WIRE	
110 VOLT RECEPTACLE GROUND FAULT INTERRUPTER	@
GARAGE DOOR OPENER	9
INCANDESCENT LIGHT TUBE	
CEILING FAN W/OPT. LIGHT	*
CEILING PENDANT LIGHT	
OUTDOOR WALL LIGHT	Ð
VANITY LIGHTS	000
110 VOLT EXTERIOR RECEPTACLE GROUND FAULT INTERRUPTER	@

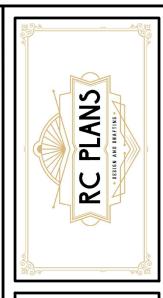


214-859-4267

THESE PLANS AND SPECIFICATIONS ARE INTENDED SOLELY FOR USE ON THE DESIGNATED SITE FOR WHICH THEY WERE CREATED, ANY REPRODUCTION OR DISTRIBUTION IS STRICTLY CONFINED TO THIS PURPOSE, REPRODUCTION, REUSE, OR DISCLOSURE—WHETHER IN FULL OR PARTIAL FORM AND BY ANY MEANS—OUTSIBLE OF THIS INTENDED USE IS PROHIBITED, RCPLANS LLC RETAINS OWNERSHIP AND PROPRIETARY RIGHTS TO THE INFORMATION CONTAINED WITHIN THESE DRAWINGS AND SPECIFICATIONS.

USE:	RESIDENTIAL NEW
	DUPLEX
	CONSTRUCTION
PLAN:	ELECTRICAL PLAN
DRAWN BY:	RC PLANS
DATE:	11/18/2024
SCALE	1/8" = 1'-0"


ADDRESS:

117 N VAN **BUREN** AVE, DALLAS, TX 75208

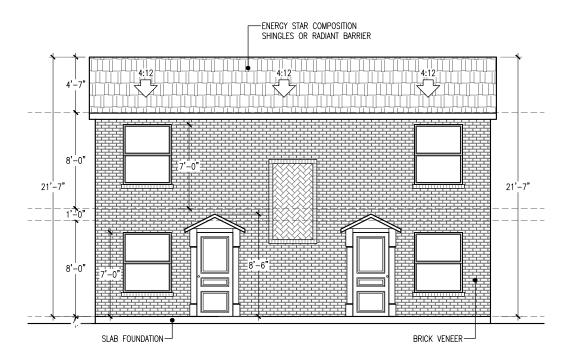


PROPOSED FRONT ELEVATION

SCALE 1/8" = 1'-0"

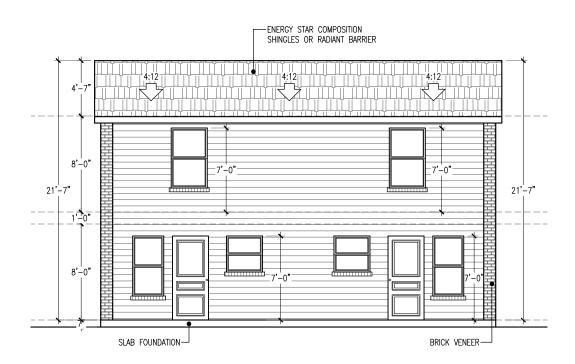


PROPOSED REAR ELEVATION

SCALE 1/8" = 1'-0"

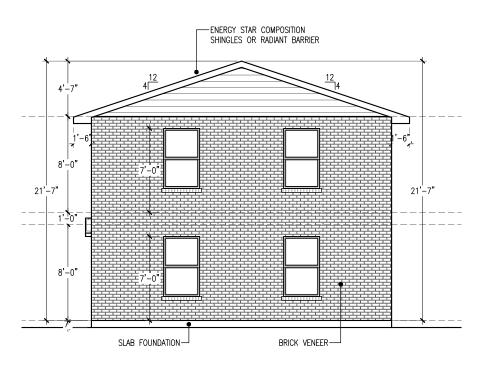

PROPOSED RIGHT ELEVATION

SCALE 1/8" = 1'-0"

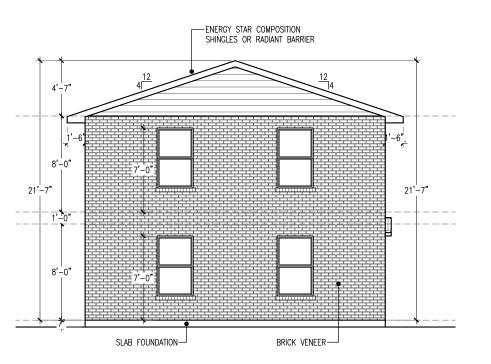

PROPOSED LEFT ELEVATION

SCALE 1/8" = 1'-0"



214-859-4267


THESE PLANS AND SPECIFICATIONS ARE INTENDED SOLELY FOR USE ON THE DESIGNATED SITE FOR WHICH THEY WERE CREATED. ANY REPRODUCTION OR DISTRIBUTION IS STRICTLY CONFINED TO THIS PURPOSE. REPRODUCTION, REUSE, OR DISCLOSURE—WHETHER IN FULL OR PARTIAL FORM AND BY ANY MEANS—OUTSIDE OF THIS INTENDED USE IS PROHIBITED. RCPLANS LLC RETAINS OWNERSHIP AND PROPRIETARY RIGHTS TO THE INFORMATION CONTAINED WITHIN THESE DRAWINGS AND SPECIFICATIONS.

USE:	RESIDENTIAL NEW DUPLEX CONSTRUCTION
PLAN:	ELEVATION
DRAWN BY: RC PLANS	RC PLANS
DATE:	11/18/2024
SCALE:	1/8" = 1'-0"

ADDRESS:


117-119 N VAN BUREN AVE, DALLAS, TX 75208

PAGE NUMBER:

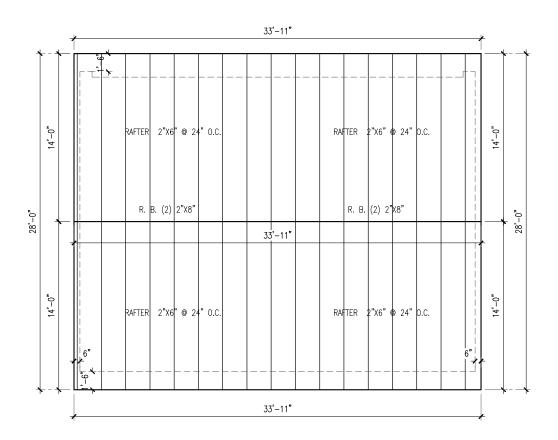

ROOF FRAMING PLAN

SCALE 1/8" = 1'-0"

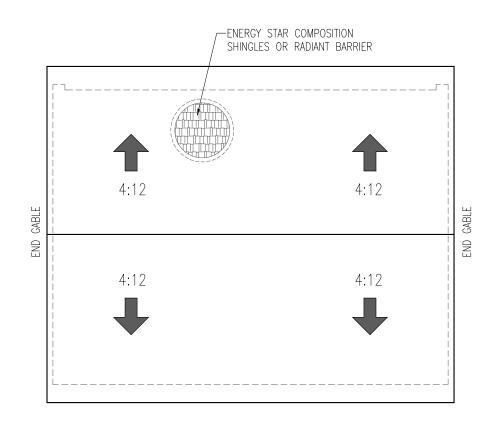

ROOF PLAN


N.T.S.


HEADER SPAN TABLE

SPAN	SINGLE STORY	TWO STORY
0' TO 4'	4"X4"	6"X6"
4' TO 6'	4"X6"	6"X8"
6' TO 8'	4"X8"	6"X10"
8' TO 10'	4"X10"	6"X12"
10' TO 12'	4"X12"	6"X14"

MAXIMUM STUD HEIGHT TABLE


STUD HEIGHT BEARING WALL NON-BEARING WALL 0' TO 10' 2"X6" 2"X4"

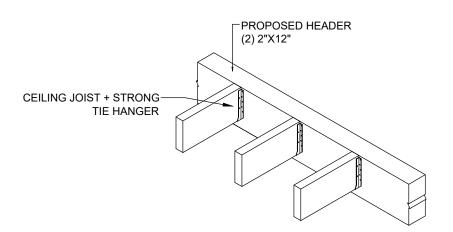

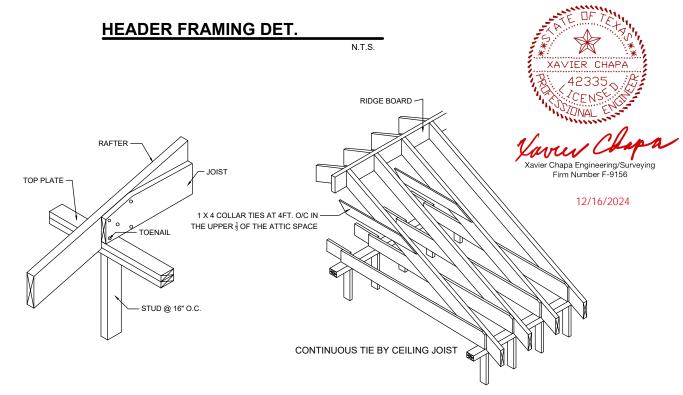

RAFTER BRACE DET.

TS

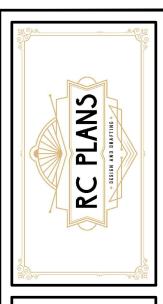

214-859-4267

THESE PLANS AND SPECIFICATIONS ARE INTENDED SOLELY FOR USE ON THE DESIGNATED SITE FOR WHICH THEY WERE CREATED. ANY REPRODUCTION OR DISTRIBUTION IS STRICTLY CONFINED TO THIS PURPOSE. REPRODUCTION, REUSE, OR DISCLOSURE—WHETHER IN FULL OR PARTIAL FORM AND BY ANY MEANS—OUTSIBE OF THIS INTENDED USE IS PROHIBITED. RCPLANS LLC RETAINS OWNERSHIP AND PROPRIETARY RIGHTS TO THE INFORMATION CONTAINED WITHIN THESE DRAWINGS AND SPECIFICATIONS.

USE:	RESIDENTIAL NEW DUPLEX
	CONSTRUCTION
PLAN:	FRAMING PLAN
DRAWN BY:	RC PLANS
DATE:	11/18/2024
SCALE:	1/8" = 1'-0"

ADDRESS:

117 N VAN BUREN AVE, DALLAS, TX 75208

PAGE NUMBER: